P.E.

STATE OF MISSISSIPPI

MISSISSIPPI DEPARTMENT OF TRANSPORTATION


PLANS OF PROPOSED


DISTRICT 3 MATERIALS LAB HVAC AND LIGHTING REPLACMENT AT YAZOO CITY

STATE PROJECT NO. BWO-3074-82(004)

YAZOO COUNTY


CONSTRUCTION FMS NOS. 503088/301000

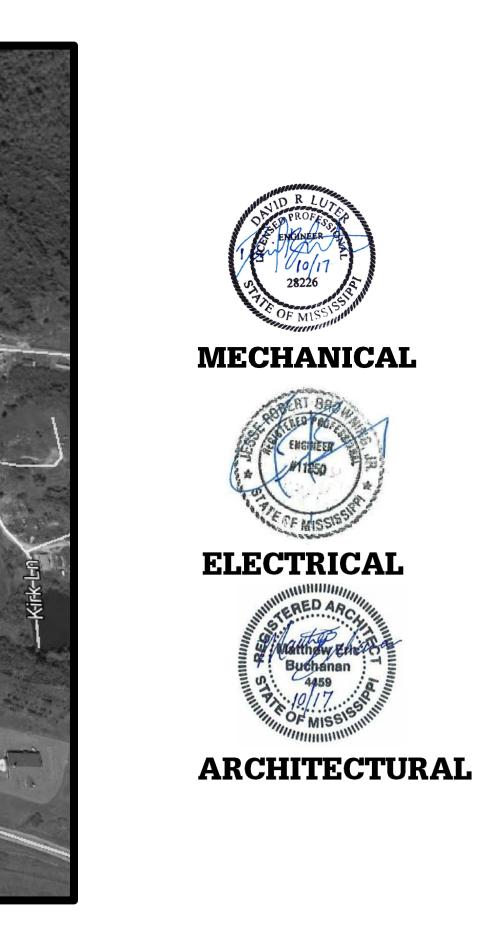

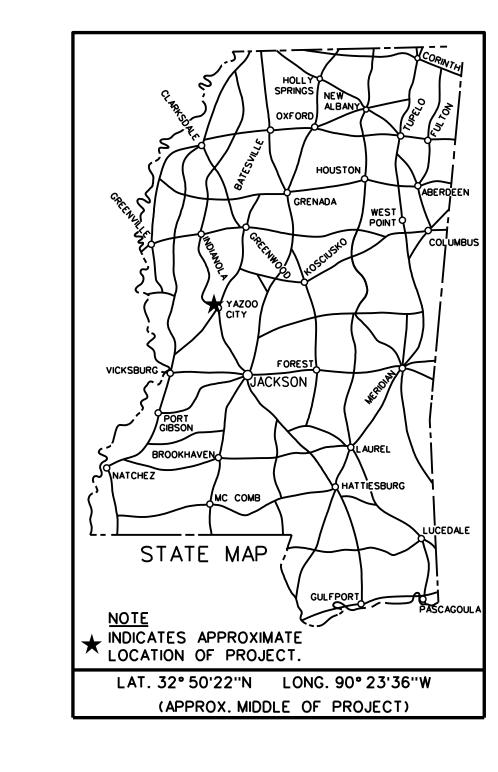

PROJECT NO.

1240 Highway 49, West, Yazoo City, MS 39194

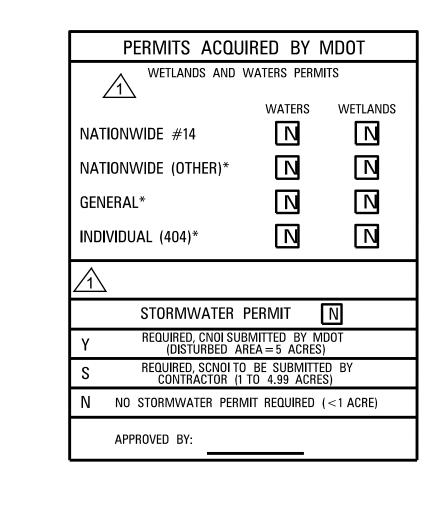

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	\leq		P S & E DATE: 10/16/2017
	BLL	ВУ	APPROVED:
		NS	DEPUTY EXECUTIVE DIRECTOR / CHIEF ENGINEER
		REVISIONS	EXECUTIVE DIRECTOR
	REMOVED NOTE	R	
	10/25/17	DATE	MISSISSIPPI DEPARTMENT OF TRANSPORTATION

1st O.REV. STATE PROJECT NO. BWO-3074-82(004)

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	FMS CON. # 503088 / 301000)
	REVISIONS	
DATE	SHEET NO.	BY
10/25/17	1	BLI



MISSISSIPPI DEPARTMENT OF TRANSPORTATION DISTRICT 3 MATERIALS LAB HVAC AND LIGHTING REPLACEMENT

DETAILED INDEX


Project Number: BWO-3074-82(004)

COUNTY: YAZOO

발 FILENAME: BWO-3074-82(004)-DI-1.dgn CHECKED DRL DATE: 10/16/17

WORKING NUMBER

DI-1 SHEET NUMBER

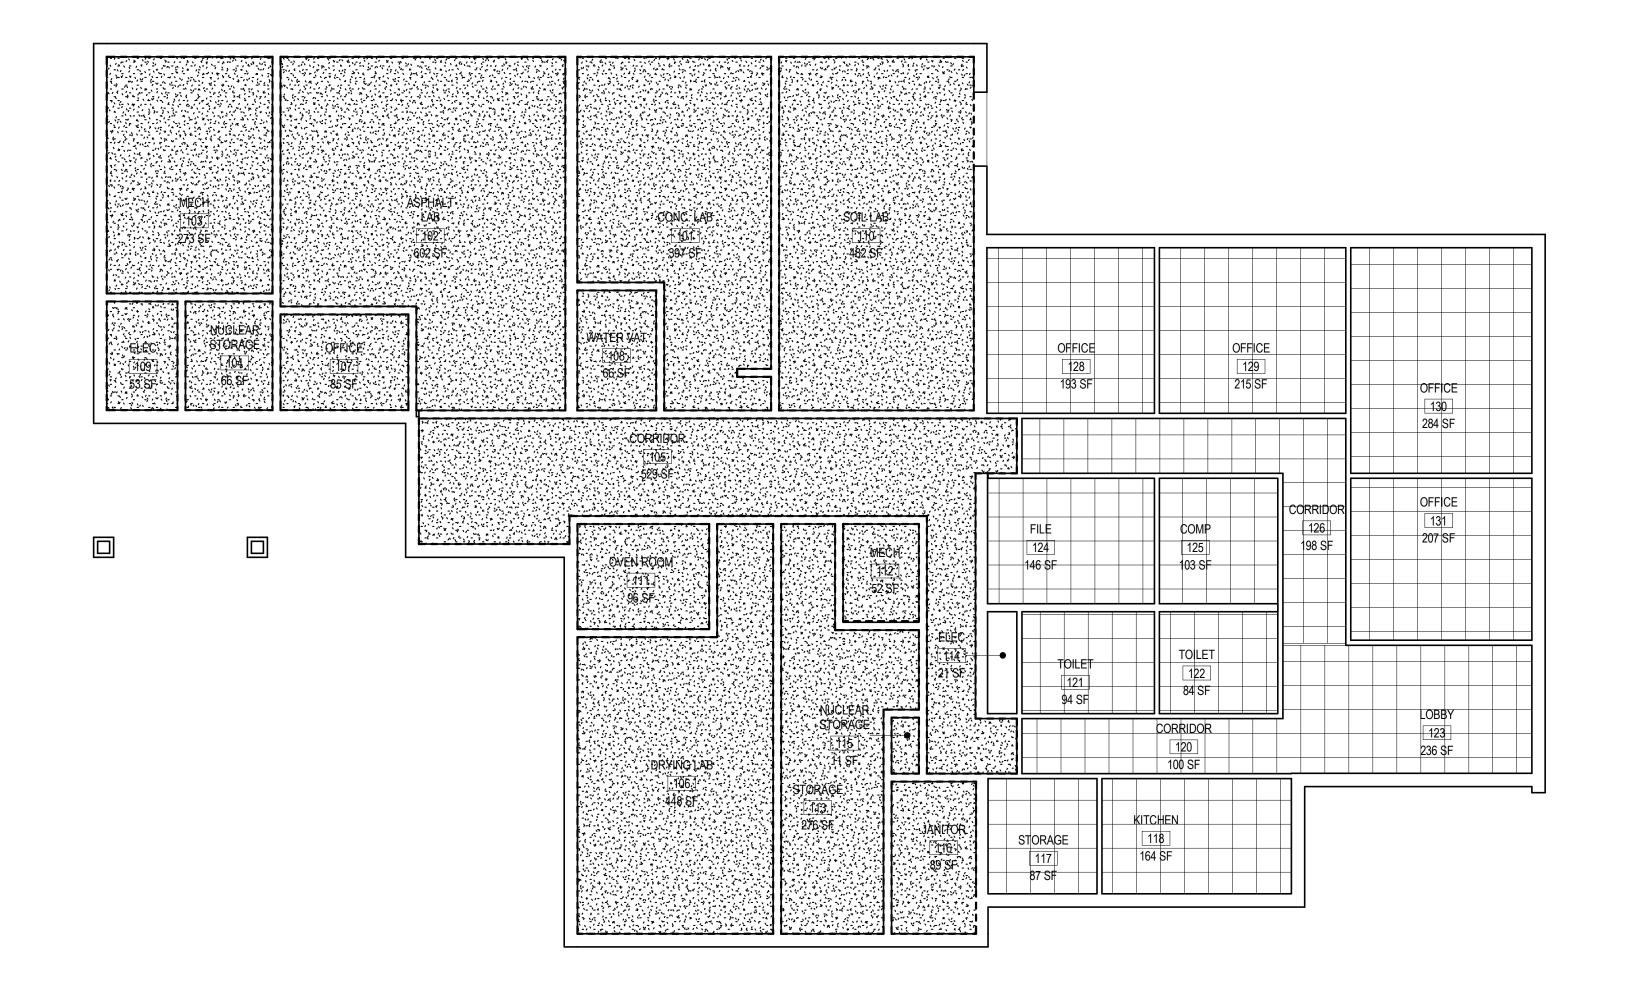

1 AD-101 FIRST FLOOR REFLECTED CEILING DEMO PLAN

1/8" = 1'-0"

GENERAL DEMOLITION NOTES

1. DEMO ALL CEILINGS SHOWN ON PLAN

- 2. ALL INFORMATION IS BASED ON OWNER SUPPLIED DOCUMENTS AND FIELD OBSERVATIONS AND MAY NOT REFLECT COMPLETELY ACTUAL FIELD CONDITIONS. UPON DISCOVERY OF ANY INCONSISTENCIES BETWEEN THE DRAWINGS DESCRIBING THE EXISTING CONDITIONS OR UNKNOWN CONDITIONS THAT ARE DETRIMENTAL TO THE COMPLETION OF THE WORK AS DESCRIBED IN THE CONSTRUCTION DOCUMENTS, THE CONTRACTOR SHALL IMMEDIATELY NOTIFY THE ARCHITECT IN WRITING OF THE CONDITION IN QUESTION BEFORE PROCEEDING WITH THE WORK IN THAT AREA.
- 3. THE CONTRACTOR SHALL NOTIFY THE ARCHITECT IMMEDIATELY IN WRITING IF ANY WORK DESCRIBED IN THE CONSTRUCTION DOCUMENTS CANNOT BE PERFORMED DUE TO EXISTING FIELD CONDITIONS.
- 4. SALVAGE IS DEFINED AS CAREFULLY REMOVING AND RETAINING ITEMS FOR RE-USE OR TO BE RETURNED TO THE OWNER.
- 5. THE EXISTING FACILITIES SHALL BE SURVEYED BY THE ARCHITECT, OWNER AND CONTRACTOR PRIOR TO DEMOLITION. MATERIALS AND FIXTURES TO BE SALVAGED AND STORED FOR RE-USE AND/OR RETURNED TO THE OWNER, SHALL BE TAGGED BY THE CONTRACTOR AS DIRECTED BY THE OWNER AND SHALL BE PROTECTED.
- 6. ALL MAJOR MECHANICAL, PLUMBING AND ELECTRICAL ITEMS SHALL BE REMOVED BY THE RESPECTIVE TRADES. ALL ITEMS TO BE REMOVED ARE NOT NECESSARILY SHOWN ON THESE DOCUMENTS.
- 7. REFER TO MECHANICAL, PLUMBING AND ELECTRICAL DRAWINGS FOR DEMOLITION OF UTILITIES.
- 8. SPECIAL CARE SHALL BE TAKEN AT THE INTERFACE BETWEEN DEMOLITION AND EXISTING CONSTRUCTION TO REMAIN TO AVOID DAMAGE TO ANY SYSTEM TO REMAIN AND/OR BE RE-INSTALLED.
- 9. THE CONTRACTOR IS RESPONSIBLE FOR THE EXISTING SUBSTRATE CORRECTION IN ALL AREAS WHERE MECHANICAL, PLUMBING AND ELECTRICAL EQUIPMENT AND SERVICES ARE REMOVED AND/OR CAPPED.
- 10. IF ANY EXISTING FIREPROOFING OR OTHER RATED ASSEMBLIES WHICH ARE INDICATED TO REMAIN ARE DAMAGED DURING DEMOLITION, THE CONTRACTOR SHALL REPAIR DAMAGE TO THE LEVEL OF THE ORIGINAL FIRE PROTECTION REQUIREMENTS.


THE CONTRACTOR SHALL NOTIFY, COORDINATE, SCHEDULE AND RECEIVE PRIOR PERMISSION FROM THE OWNER IF ANY SHUTDOWN OF SERVICES IS NECESSARY TO COMPLETE THE WORK. NOTIFICATION SHALL INCLUDE THE TYPE OF SERVICE TO BE SHUT-DOWN, AREAS AFFECTED, REQUESTED SHUT-DOWN DATES AND LENGTH OF TIME SERVICE WILL BE DOWN.

SYMBOLS and DRAWING CONVENTIONS

ROOM NAME
ROOM NUMBER
ROOM AREA

150 SF

REVISION NUMBER
REVISION NUMBER

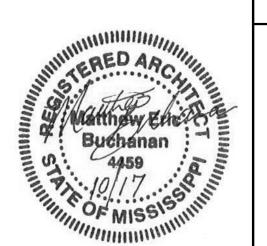

MISSISSIPPI DEPARTMENT OF TRANSPORTATION
DISTRICT 3 MATERIALS LAB HVAC AND

LIGHTING REPLACEMENT


FIRST FLOOR DEMO PLAN

Project Number: BWO-3074-82(004)

COUNTY: YAZOO

 AD-101
SHEET NUMBER
3

WORKING NUMBER

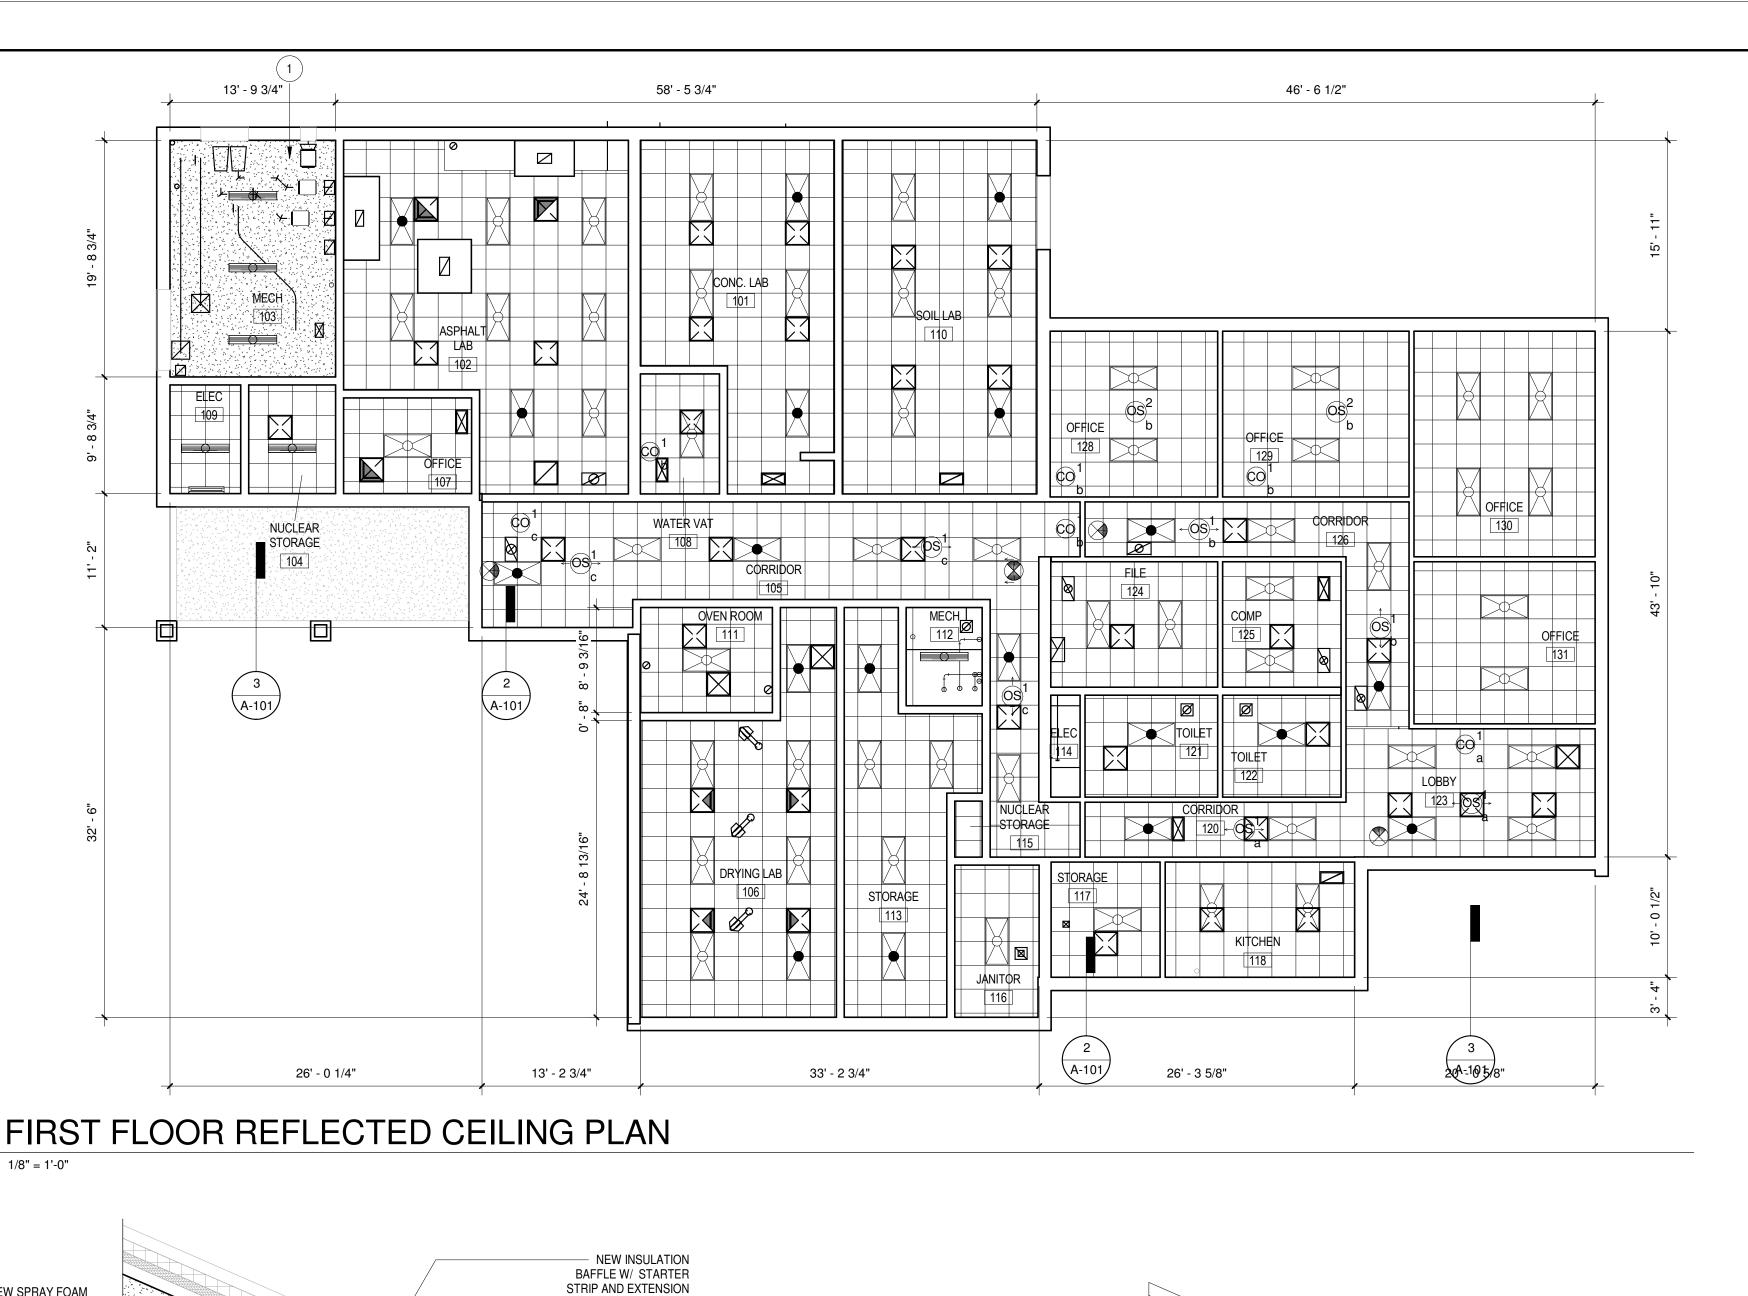


NEW SPRAY FOAM INSULATION **EXISTING ROOF** BETWEEN JOIST CONSTRUCTION REMOVE EXISTING BATT INSULATION, GYP. BD. CEILING & FURRING, TYP. NEW ACT CEILING. **EXISTING WALL** SEE PLAN FOR HEIGHT — CONSTRUCTION

A-101


A-101

1 1/2" = 1'-0"

NOTE: DETAIL APPLIES TO ENTIRE ROOF AREA ABOVE CEILING. TYPICAL ABOVE CEILING INSULATION DETAIL

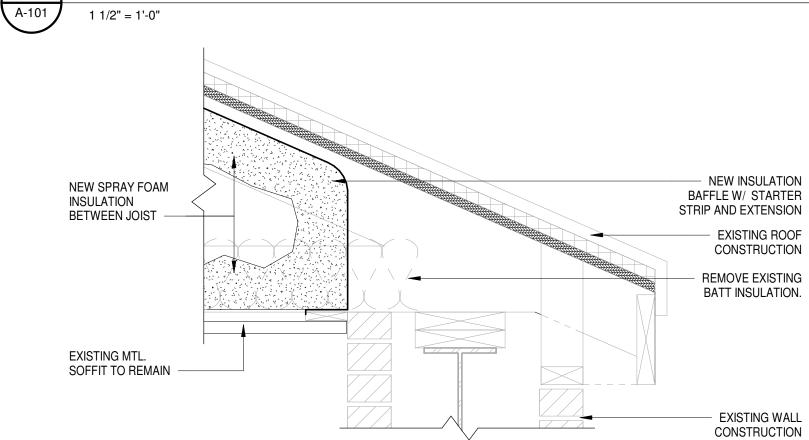

ABOVE CEILING INSULATION DETAIL @ PORCH

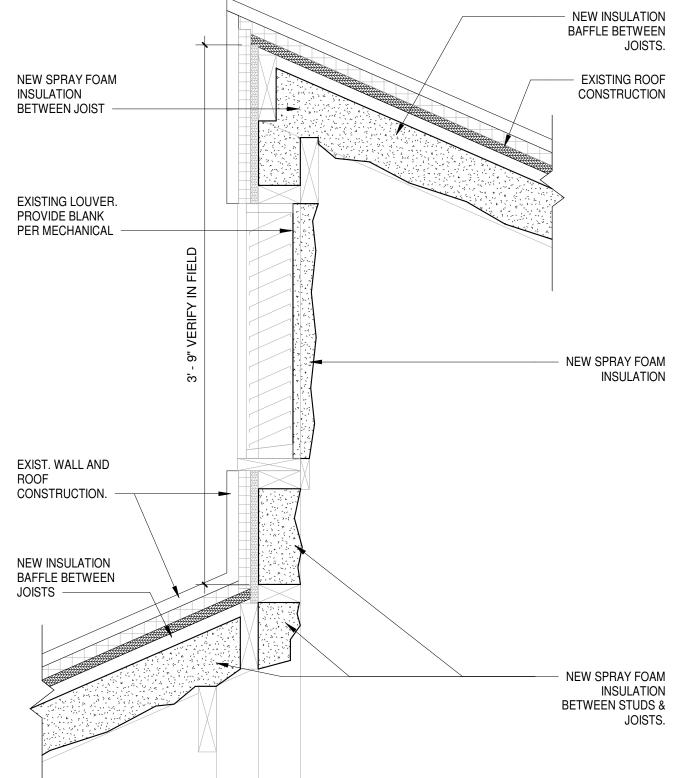

ABOVE CEILING INSULATION DETAIL @ OFFSET ROOF

PROJECT NO. STATE BWO-3074-82(004)

GENERAL ARCHITECTURAL RCP NOTES


- DIMENSIONS ARE BASED ON OWNER PROVIDED AS-BUILT FILES AND MAY NOT BE EXACT. THE CONTRACTOR SHALL FIELD VERIFY ALL DIMENSIONS PRIOR TO INSTALLATION..
- ALL CEILINGS ARE TO BE ACOUSTICAL TILE (ACT) TYPE 1 UNLESS OTHERWISE NOTED.
- CEILING HEIGHTS TO BE 8'-6". UNLESS OTHERWISE
- CONTRACTOR TO COORDINATE WITH MECHANICAL AND ELECTRICAL DRAWINGS FOR ITEMS LOCATED IN CEILING NOT SHOWN ON THIS SHEET.
- IF ACCESS PANELS ARE INDICATED OR REQUIRED, CONSULT ARCHITECT PRIOR TO PLACEMENT.
- ADVISE THE OWNER THAT AN 18" MIN. VERTICAL CLEARANCE SHALL BE MAINTAINED BETWEEN THE BOTTOM OF SPRINKLER HEADS AND THE TOP OF ANY FILES, SHELVING, LOCKERS, ETC.
- OBJECTS WHICH OCCUR ON OR IN LAY-IN CEILING TILES ARE TO BE LOCATED AT THE CENTER OF THE TILE, UNLESS OTHERWISE NOTED.
- H IN REFERENCE TO PLASTER OR GYPSUM BOARD CEILINGS; OBJECTS WHICH OCCUR BETWEEN TWO LIGHT FIXTURES ARE TO BE EQUALLY SPACED AND ALIGNED WITH THE CENTER OF LIGHT FIXTURES, UNLESS OTHERWISE NOTED.
- SPRINKLER HEAD LOCATIONS ARE NOT INDICATED ON THIS CEILING PLAN. THE CONTRACTOR SHALL INSTALL SUFFICIENT HEADS IN ALL SPACES TO PROVIDE COMPLETE (100% AUTOMATIC SPRINKLER COVERAGE AS DEFINED IN NFPA STANDARD 13)

SYMBOLS and DRAWING CONVENTIONS

OPEN: OPEN TO TYPE 1 (ACP 1): TYPE 2: STRU. ABOVE 2'X2' ACOUST. GYPSUM BOARD **CEILING PANEL** 2'X2' LIGHT FIXTURE IN ACOUSTICAL PANEL CEILING SYSTEM 2'X4' LIGHT FIXTURE IN ACOUSTICAL PANEL CEILING SYSTEM (A 1' - 0") CEILING FINISH I CEILING HEIGHT RECESSED LIGHT FIXTURE LINEAR LIGHT FIXTURE **EXIT SIGN** OCCUPANCY SENSOR SMOKE DETECTOR SMOKE DETECTOR (REFER TO FA DWGS) FIRE SPRINKLER HEAD DIFFUSER **EXHAUST FAN** RETURN

RCP KEY NOTES

1 NEW GYP. BD. CEILING ATTACHED TO EXISTING FURRING.

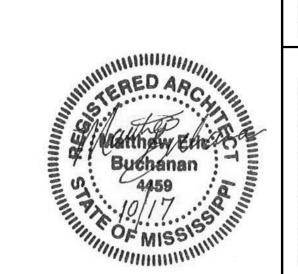

MISSISSIPPI DEPARTMENT OF TRANSPORTATION DISTRICT 3 MATERIALS LAB HVAC AND LIGHTING REPLACEMENT

FIRST FLOOR RCP

Project Number: BWO-3074-82(004)

COUNTY: YAZOO

DESIGN TEAM CDFL

FILENAME: BWO-3074-82(004)-A-101.dgn

A-101 SHEET NUMBER

WORKING NUMBER

CHECKED MEB DATE: 10/16/17

- A. LOCATIONS AND SIZES OF EXISTING EQUIPMENT, PIPING, ETC. SHOWN ON DEMOLITION PLAN(S) ARE APPROXIMATE AND MAY NOT HAVE BEEN PREVIOUSLY VERIFIED. THE CONTRACTOR IS TO VISIT PROJECT SITE PRIOR TO CONSTRUCTION AND VERIFY EXISTING SIZES, AND LOCATIONS, AS WELL AS GENERAL WORKING CONDITIONS.
- B. THE BUILDING OWNER SHALL HAVE FIRST RIGHT OF REFUSAL FOR ALL EQUIPMENT, ETC. REMOVED DURING DEMOLITION. ALL EQUIPMENT, MATERIALS, ETC. NOT CLAIMED BY THE OWNER SHALL BE REMOVED FROM THE PREMISES AND DISPOSED OF BY THE CONTRACTOR AT THE CONTRACTOR'S
- C. PATCHING OF EXISTING WALLS, FLOORS, CEILINGS, PAVING, ETC. SHALL BE PERFORMED BY THE GENERAL CONTRACTOR. THE PLUMBING CONTRACTOR IS TO IDENTIFY ALL KNOWN AREAS THAT WILL REQUIRE PATCHING AND COORDINATE WITH THE GENERAL CONTRACTOR PRIOR TO BIDDING THE PROJECT (SEE ARCHITECTURAL PLANS FOR ADDITIONAL INSTRUCTIONS REGARDING PATCHING).
- D. ALL ACCESSIBLE, ABANDONED PIPING (INCLUDING ABANDONED FIXTURE ROUGH-IN PIPING) IS TO BE REMOVED UNLESS NOTED OTHERWISE. REMAINING PIPING IS TO BE CAPPED OFF IN WALLS, ABOVE CEILINGS, AND/OR BELOW FLOORS.
- E. ANY AND ALL EXISTING PIPING DISCOVERED DURING DEMOLITION (BUT NOT NECESSARILY SHOWN ON PLANS) THAT IS REQUIRED TO REMAIN IN SERVICE, IS TO BE REROUTED AND RECONNECTED AS REQUIRED. UPON DISCOVERY OF SUCH CONDITIONS, THE CONTRACTOR IS TO CONTACT THE MECHANICAL ENGINEER FOR INSTRUCTIONS.
- F. THE CONTRACTOR IS TO PERFORM ALL WORK ACCORDING TO PROJECT PHASING GUIDELINES. WHERE PROJECT PHASING IS NOT ADDRESSED ON PLANS OR IN SPECIFICATIONS, ALL WORK (IN BUILDING(S) OR ON SITE) ANTICIPATED TO CAUSE DISRUPTION OR OTHERWISE AFFECT PLUMBING SYSTEMS AND/OR BUILDING OCCUPANTS IN OTHER AREAS OF THE BUILDING IS TO BE SCHEDULED WITH THE BUILDING
- G. ANY AND ALL TEMPORARY PLUMBING SERVICES ARE TO BE PROVIDED BY AND PAID FOR BY THE CONTRACTOR.

GENERAL PLUMBING NOTES - NEW CONSTRUCTION

- A. THE CONTRACTOR IS RESPONSIBLE FOR COORDINATION OF ALL PLUMBING INSTALLATIONS WITH ALL OTHER TRADES (HVAC, FIRE PROTECTION, ELECTRICAL, LIGHTING, STRUCTURAL, CEILING CONSTRUCTION AND SUPPORTS, AND ETC.). ANY CONFLICTS ARISING DUE TO A LACK OF CONSTRUCTION COORDINATION OR CONSIDERATION FOR THE REQUIREMENTS OF OTHER TRADES SHALL BE RESOLVED AT NO EXPENSE TO THE OWNER.
- B. NO PLUMBING SYSTEMS ARE TO BE INSTALLED IN OR ABOVE ANY ELECTRICAL OR COMMUNICATIONS ROOM, ELEVATOR SHAFT, ELEVATOR EQUIPMENT ROOM OR STAIRWELL UNLESS SHOWN ON PLANS.
- C. REFER TO ARCHITECTURAL PLANS FOR INSTALLATION DIMENSIONS FOR ALL PLUMBING FIXTURES.
- D. WHERE POSSIBLE, VALVES AND DEVICES IN ABOVE-CEILING PIPING ARE TO BE INSTALLED ABOVE ACCESSIBLE CEILINGS AND CLEANOUTS EXTENDED TO ABOVE ACCESSIBLE CEILINGS. WHERE INSTALLED ABOVE INACCESSIBLE CEILINGS, ACCESS PANELS ARE TO BE INSTALLED.
- E. ACCESS PANELS ARE TO BE ADEQUATELY SIZED TO ALLOW FOR OPERATION AND MAINTENANCE OF ALL CONCEALED VALVES, CLEANOUTS, EQUIPMENT, ETC. AND ARE TO HAVE SAME SMOKE/FIRE RATING AS WALLS AND CEILINGS IN WHICH THEY ARE INSTALLED.

F. ESCUTCHEONS ARE TO BE FURNISHED AND INSTALLED FOR ALL EXPOSED PIPE PENETRATIONS OF WALLS AND PARTITIONS AND FOR PIPE PENETRATIONS (EXPOSED AND CONCEALED) OF MILLWORK AND CASEWORK.

- G. ALL THRU-PENETRATIONS OF WALLS AND PARTITIONS ARE TO BE SLEEVED (SEE SPECIFICATIONS).
- H. ALL PENETRATIONS OF RATED WALLS, FLOORS, AND ASSEMBLIES ARE TO BE SLEEVED AND FIRESTOPPED (SEE SPECIFICATIONS).
- PIPE INSULATION IS TO BE RUN CONTINUOUS (UNCUT) THRU WALL STUDS. PIPE HANGERS AND SUPPORTS, AND WALL AND FLOOR PENETRATIONS.
- J. MASTIC IS TO BE APPLIED TO ALL RAW EDGES OF PIPING INSULATION.
- K. VALVES INSTALLED IN INSULATED PIPING ARE TO BE INSULATED AND SHUT-OFF VALVES PROVIDED WITH EXTENDED STEMS.
- L. WATER HAMMER ARRESTORS ARE TO BE INSTALLED AS CLOSE TO CONNECTIONS TO PIPES SERVED AS POSSIBLE. ACCESS PANELS, WHERE SHOWN ON RISER DIAGRAMS, ARE TO BE INSTALLED CLEAR OF FIXTURES, MILLWORK, TOILET GRAB BARS, ETC.
- M. GRAVITY-FLOW PIPING 2-1/2" AND SMALLER IS TO BE RUN AT A MINIMUM SLOPE OF 1/4" PER FOOT. GRAVITY-FLOW PIPING 3" AND LARGER IS TO BE RUN AT A MINIMUM SLOPE OF 1/8" PER FOOT.
- N. ANY INDIRECT DRAIN PIPED TO AN OPEN RECEPTOR (FLOOR DRAIN, ETC.) IS TO TURN DOWN OVER RECEPTOR, LEAVING AIR GAP BETWEEN END OF DRAIN AND FLOOD LEVEL RIM OF RECEPTOR. AIR GAP SHALL BE EQUAL TO TWICE THE EFFECTIVE OPENING OF THE INDIRECT DRAIN PIPE.
- O. ALL ABOVE-SLAB CONDENSATE DRAINS ARE TO BE INSULATED PER SPECIFICATIONS. ALL ABOVE-SLAB SANITARY BRANCH LINES AND TRAPS CONNECTED TO RECEPTORS THAT RECEIVE CONDENSATE ARE TO BE INSULATED AS FOR CONDENSATE DRAINS, PER SPECIFICATIONS.
- P. FOR BARE COPPER PIPING, COPPER HANGERS OR HANGERS WITH RUBBER/POLYCARBONATE ATTACHMENTS ARE REQUIRED IN ORDER TO PREVENT GALVANIC CORROSION. TAPE IS NOT AN ACCEPTABLE DIELECTRIC SEPARATION.
- Q. WHERE BARE COPPER PIPING IS ROUTED THROUGH OR AGAINST STUDS, RUBBER OR POLYCARBONATE SPACERS ARE REQUIRED.
- R. REFER TO HVAC PLANS FOR PIPE SUPPORT DETAILS.
- S. CONCRETE HOUSEKEEPING PADS (WITH CHAMFERED EDGES) FOR FLOOR-MOUNTED EQUIPMENT ARE TO BE PROVIDED BY GENERAL CONTRACTOR.
- T. ALL PLUMBING SYSTEMS AND EQUIPMENT ARE TO BE INSTALLED PER CONTRACT DOCUMENTS. THE CONTRACTOR MUST REQUEST AND RECEIVE DOCUMENTED APPROVAL FROM THE MECHANICAL ENGINEERS PRIOR TO DEVIATING FROM CONTRACT DOCUMENTS.
- U. CONTRACTOR SHALL REFER TO ARCHITECTURAL FOR PHASING OF WORK.

PLUMBING PIPING & SYMBOL LEGEND						
SANITARY SOIL / WASTE	SW	GATE VALVE	OR			
SANITARY VENT	SV	BALL VALVE	<u> </u>			
GREASE WASTE	GW-	BUTTERFLY VALVE	——————————————————————————————————————			
STORM DRAIN	SD=	GAS COCK				
PRIMARY STORM DRAIN	PSD=	CHECK VALVE - ARROW INDICATES FLOW DIRECTION				
SECONDARY STORM DRAIN	SSD=	FLOW MEASURING / SETTING DEVICE (BALANCING VALVE)				
DOMESTIC COLD WATER	DCW	PRESSURE REDUCING VALVE				
DOMESTIC HOT WATER (110°)	DHW	RELIEF VALVE	<u> </u>			
DOMESTIC HOT WATER RECIRC. LINE (110°)	DHWR	GAGE	<u> </u>			
DOMESTIC HOT WATER (140°)	—140° DHW———	UNION				
DOMESTIC HOT WATER RECIRC. LINE (140°)	—140° DHWR—	MANUAL AIR VENT	<u> </u>			
GAS (NATURAL)	G	GAGE COCK	<u> </u>			
EQUIPMENT DRAIN	D	WATER HAMMER ARRESTOR (LETTER = PDI SIZE)				
CONDENSATE DRAIN	CD	THERMOMETER				
PUMPED CONDENSATE	PC	THERMOMETER WELL	т			
FIRE PROTECTION	F	WYE STRAINER				
PIPE DROP	—⇒ OR □□	HOSE BIBB				
PIPE RISE	—• OR □□	CONCRETE THRUST BLOCK	←			
PIPE TEE OFF BOTTOM	→ OR □□□□	NEW CONNECTION TO EXISTING	→			
CLEANOUT	—— ı <u>со</u>	LIMITS OF DEMOLITION				
WALL CLEANOUT	─ <mark>G</mark> I <u>wco</u>	FINISHED FLOOR CLEANOUT	● <u>FCO</u>			
FIRE SPRINKLER HEAD	X	FINISHED GRADE CLEANOUT	• FGCO			
PLAN NOTE DESIGNATION	(#)	VENT THROUGH ROOF	◎ #" VTR			

PLUMBING ABBREVIATIONS									
AAV	AIR ADMITTANCE VALVE	FGCO	FINISHED GRADE CLEANOUT	NTS	NOT TO SCALE				
AFF	ABOVE FINISHED FLOOR	GPH	GALLONS PER HOUR	PSD	PRIMARY STORM DRAIN				
AFG	ABOVE FINISHED GRADE	GPM	GALLONS PER MINUTE	SSD	SECONDARY STORM DRAIN				
BE	BOTTOM ELEVATION	GW	GREASE WASTE	SV	SANITARY VENT				
CA	COMPRESSED AIR	НВ	HOSE BIBB	SW	SANITARY WASTE				
CAD	COMPRESSED AIR - DROP	HBF	HOSE BIBB (FREEZE-PROOF)	TP	TRAP PRIMER				
CFH	CUBIC FEET PER HOUR	HC	GALLONS PER MINUTE	TYP	TYPICAL				
CO	CLEANOUT	HW	DOMESTIC HOT WATER	VTR	VENT THROUGH ROOF				
CW	DOMESTIC COLD WATER	HWR	DOMESTIC HOT WATER RECIRCULATION	WCO	WALL CLEANOUT				
FCO	FINISHED FLOOR CLEANOUT	MBH	THOUSANDS OF BTU/HR	WH	WATER HEATER				
FD	FLOOR DRAIN	NG	NATURAL GAS	WHA	WATER HAMMER ARRESTOR				



MISSISSIPPI DEPARTMENT OF TRANSPORTATION DISTRICT 3 MATERIALS LAB HVAC AND LIGHTING REPLACEMENT

PLUMBING GENERAL NOTES **& LEGEND**


Project Number: BWO-3074-82(004)

DESIGN TEAM CDFL

COUNTY: YAZOO 비 FILENAME: BWO-3074-82(004)-P-001.dgn CHECKED DRL DATE: 10/16/17

P-001 SHEET NUMBER

WORKING NUMBE

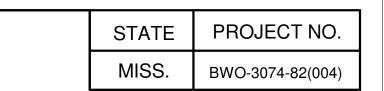

GENERAL PLAN NOTES:

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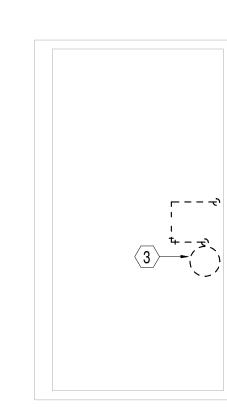
METER TO RÉMAIN.

— EXISTING GAS PIPING TO REMAIN.

- A. SEE GENERAL DEMOLITION NOTES FOR ADDITIONAL
- DEMOLITION REQUIREMENTS. SEE HVAC DEMOLITION PLANS.
- SEE ELECTRICAL DEMOLITION PLANS.
- D. UNLESS OTHERWISE NOTED, ALL PLUMBING EQUIPMENT, FIXTURES, SANITARY WASTE AND VENT PIPING, DOMESTIC WATER PIPING, NATURAL GAS PIPING, VALVES, ETC ARE TO REMAIN IN PLACE AND SERVICE. CONTRACTOR IS TO TAKE NECESSARY MEASURES TO PROTECT EXISTING FIXTURES AND PIPING FROM DAMAGE DURING WORK.

SPECIFIC PLAN NOTES:

- 1 SEE WATER HEATER ROOM PLAN FOR WORK IN ATTIC AREA ABOVE.
- REMOVE GAS PIPING FROM ABOVE BACK TO MAIN. INSTALL FULL-SIZE GAS COCK IN BRANCH AND CAP.
- 3 REMOVE EXISTING WATER HEATER, GAS PIPING AND ALL ACCESSORIES. REMOVE DOMESTIC COLD AND HOT WATER BACK TO MAIN. INSTALL FULL-SIZE BALL VALVE IN DOMESTIC COLD AND HOT WATER BRANCHES.
- 4 REMOVE GAS PIPING DOWN TO BOILERS. INSTALL FULL-SIZE GAS COCK AND CAP.
- REMOVE CHILLED AND HEATING WATER MAKEUP PIPING AND BACKFLOW PREVENTER BACK TO ABOVE CONDITIONED SPACE. INSTALL FULL SIZE BALL VALVE AND CAP.



WATER HEATER ROOM PLAN (IN ATTIC)

PLUMBING DEMOLITION PLAN

3/16" = 1'-0"

— EXISTING GAS PIPING TO REMAIN.

EXISTING GAS
PIPING TO REMAIN.

DOMESTIC WATER

EXISTING GAS

PIPING TO REMAIN.

TO REMAIN.



MISSISSIPPI DEPARTMENT OF TRANSPORTATION
DISTRICT 3 MATERIALS LAB HVAC AND

LIGHTING REPLACEMENT

PLUMBING DEMOLITION PLAN

Project Number: BWO-3074-82(004)


COUNTY: YAZOO

FILENAME: _____BWO-3074-82(004)-P-100.dgn

DESIGN TEAM _ CDFL ____ CHECKED _ DRL __ DATE; ____ 10/16/17

P-100 SHEET NUMBER 6

WORKING NUMBER

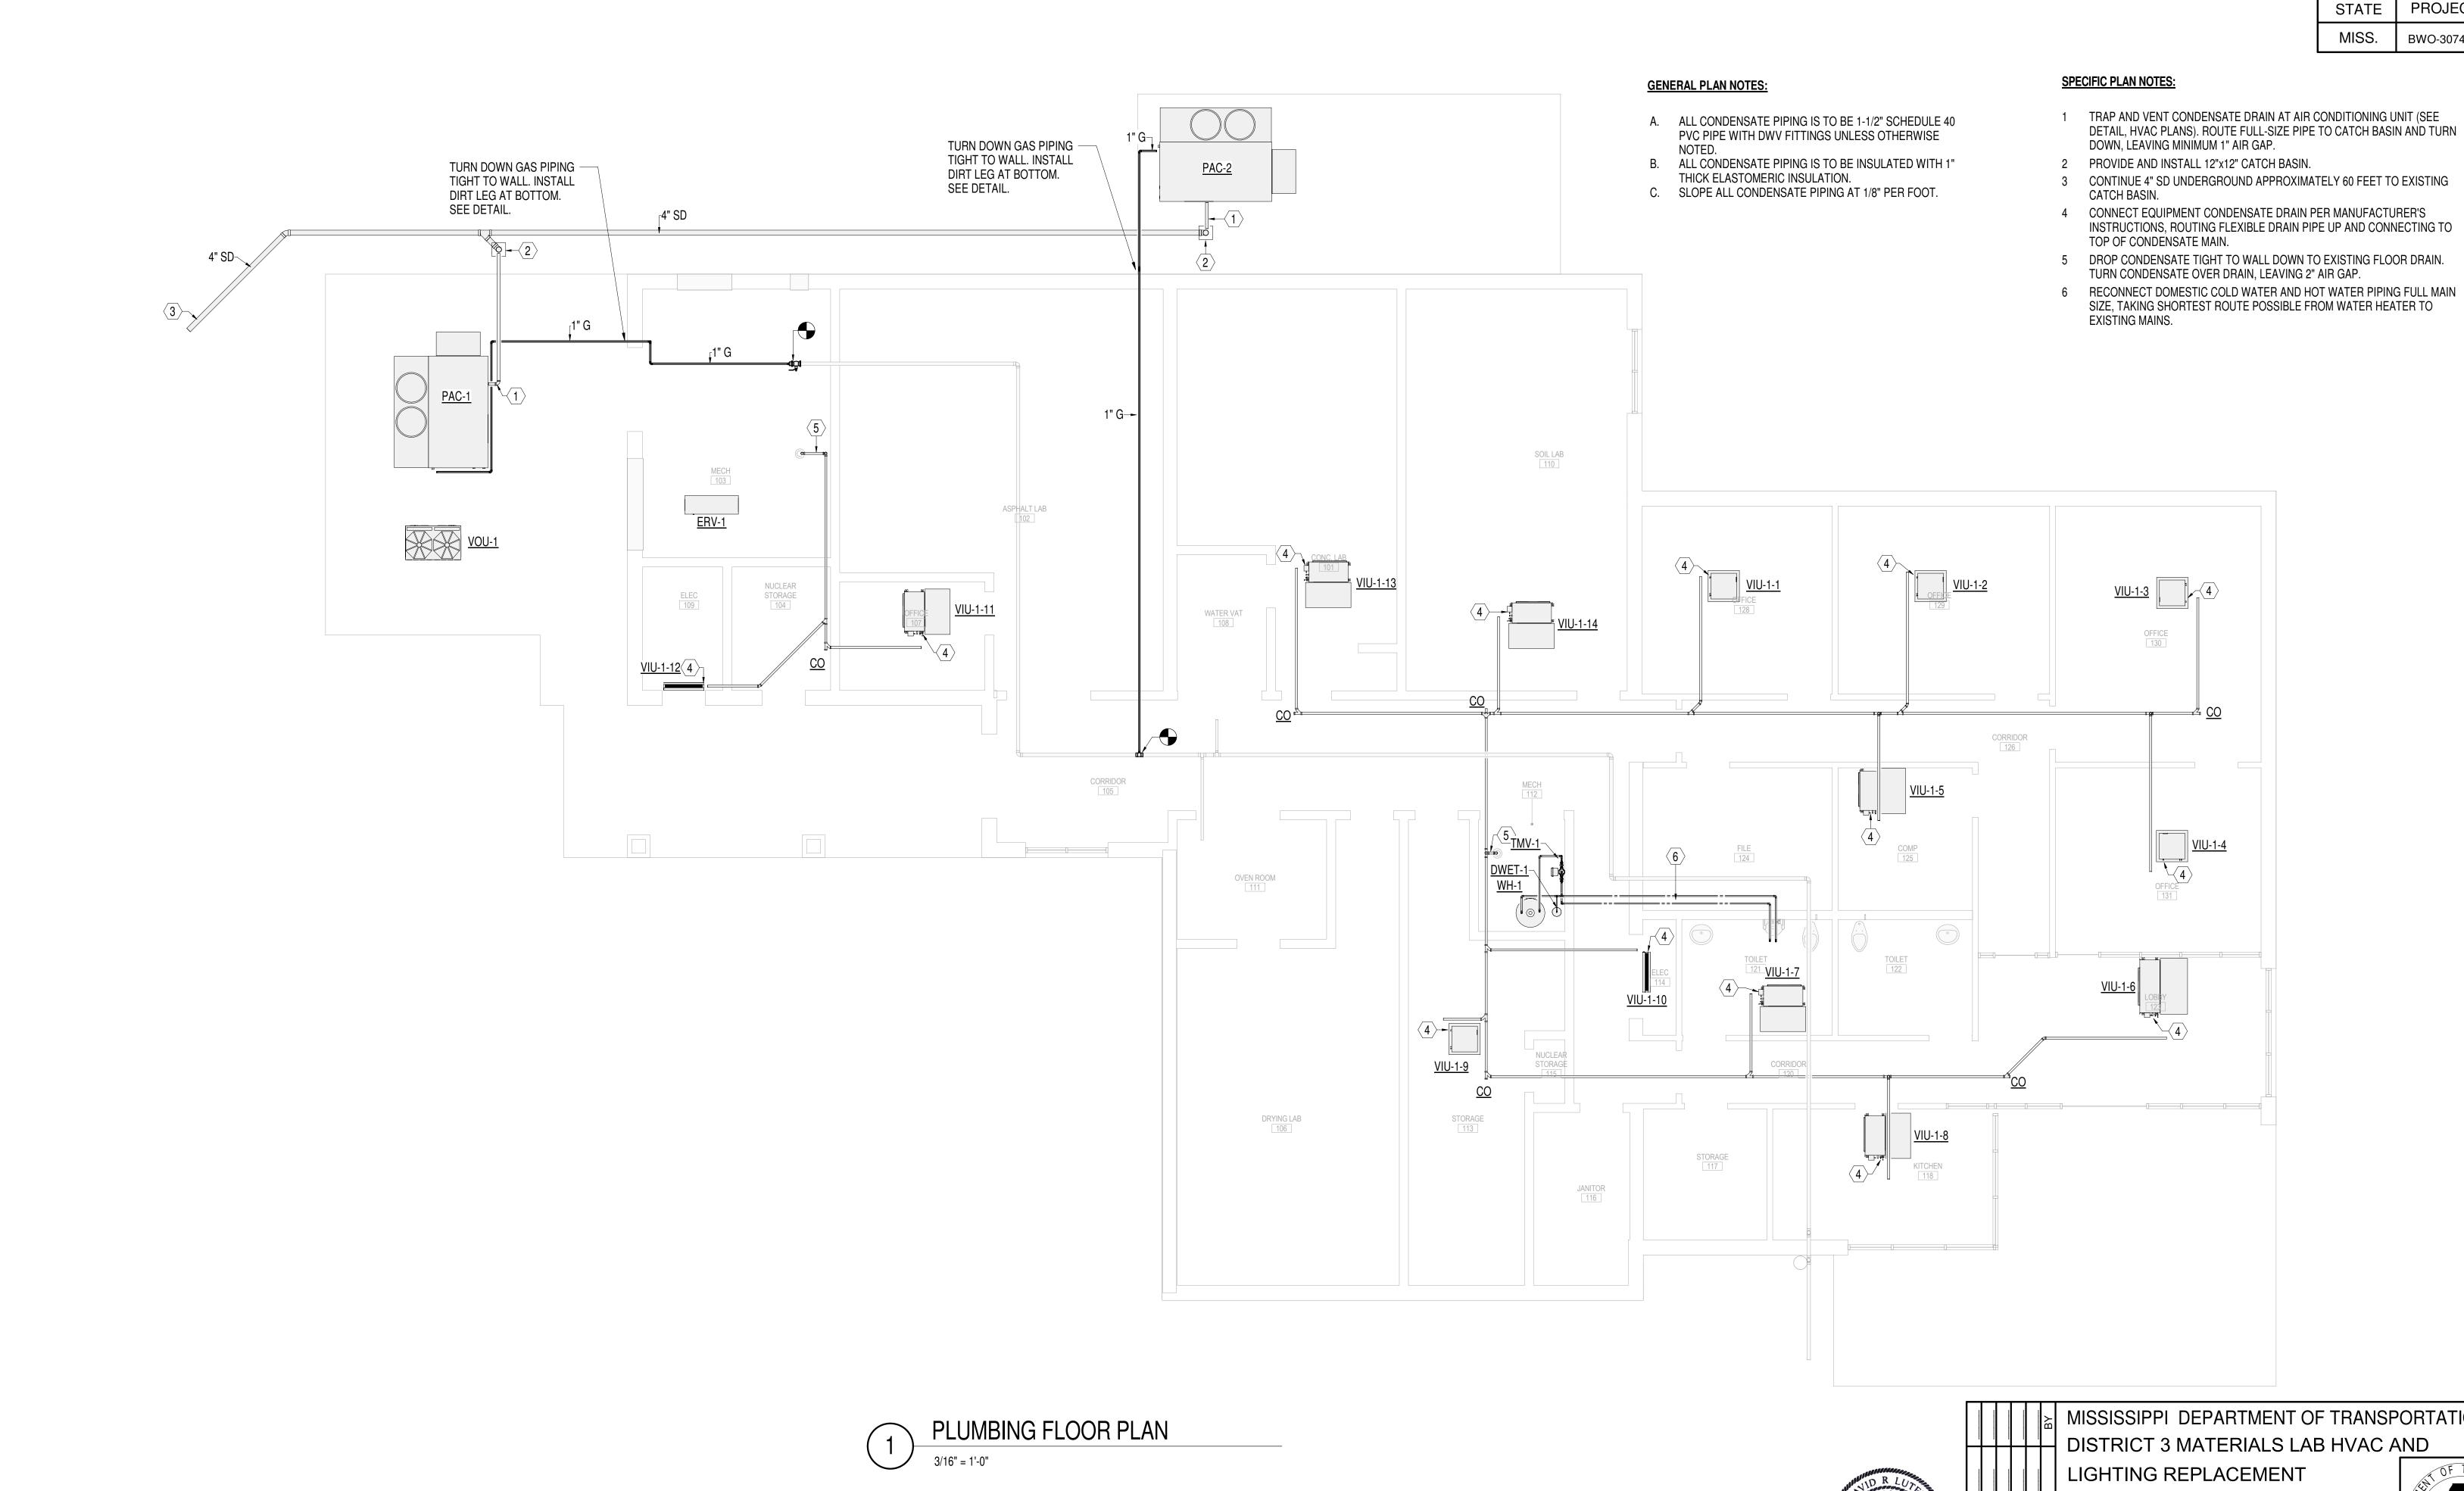

MISSISSIPPI DEPARTMENT OF TRANSPORTATION DISTRICT 3 MATERIALS LAB HVAC AND

PLUMBING FLOOR PLAN

Project Number: BWO-3074-82(004)

COUNTY: YAZOO


뿌 FILENAME: BWO-3074-82(004)-P-101.dgn CHECKED DRL DATE: 10/16/17


P-101 SHEET NUMBER

WORKING NUMBER

PROJECT NO.

BWO-3074-82(004)

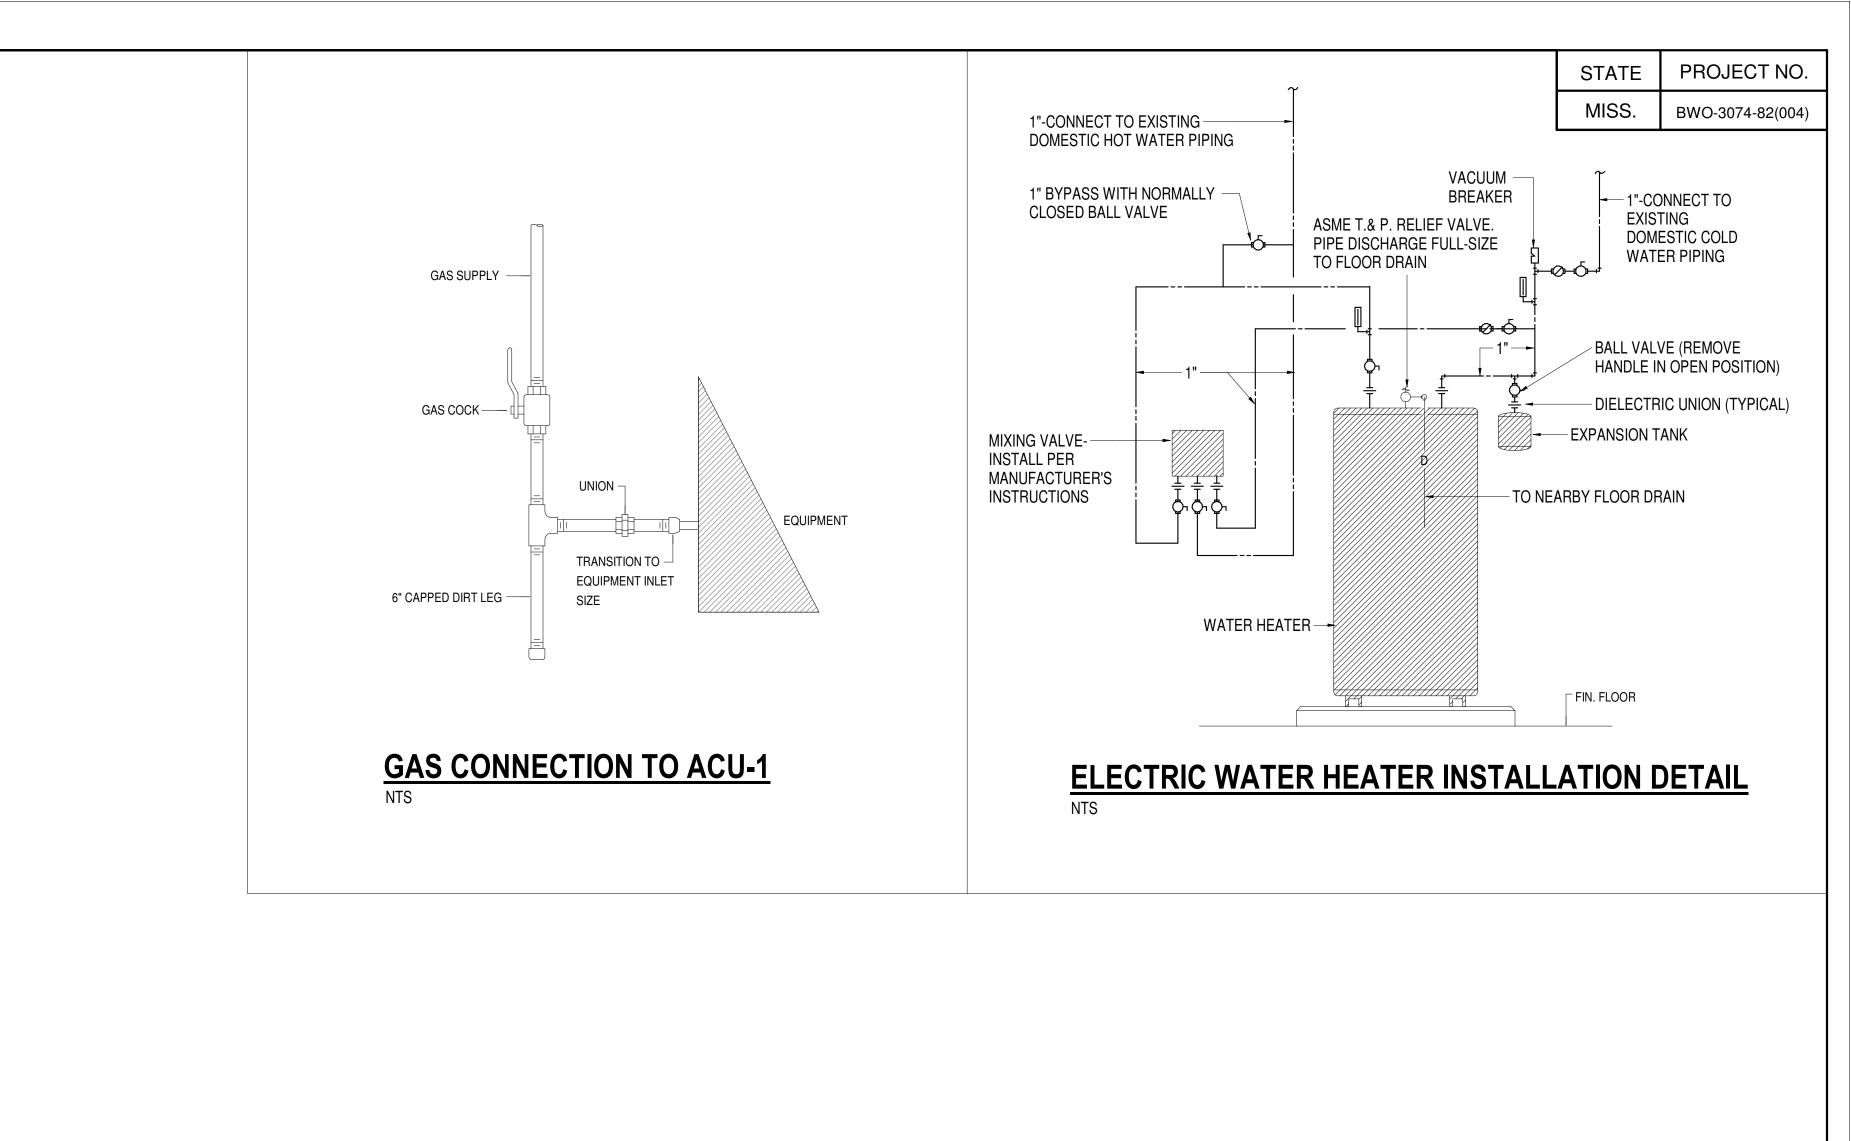

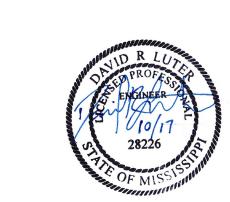

MISSISSIPPI DEPARTMENT OF TRANSPORTATION DISTRICT 3 MATERIALS LAB HVAC AND LIGHTING REPLACEMENT

PLUMBING DETAILS

Project Number: BWO-3074-82(004)

COUNTY: YAZOO 발 FILENAME: BWO-3074-82(004)-P-501.dgn

SHEET NUMBER CHECKED DRL DATE: 10/16/17

WORKING NUMBER P-501

DOMESTIC WATER THERMAL EXPANSION TANK SCHEDULE TANK VOLUME ACCEPTABLE MAX. OPERATING DIMENSIONS CONNECTION DIMENSIONS										
MARK	MAKE	MODEL	TANK VOLUME	ACCEPTABLE	MAY ODERATING DRESSTRE (DSI)				CONNECTION	NOTES
1111/1111	W (1 C		(GAL)	VOLUME (GAL)	in ou or Entrinted Fitzeronic (Feb.)	TEMPERATURE (°F)	HEIGHT	DIAMETER	SIZE	110120
DWET-1	ELBI	DTS-19	5.0	5.0	150	240	19.3"	10.6"	3/4"	1,2
COMPARABLE PRODUCTS: ELBI, A.O. SMITH, AMTROL										
NOTES:										
	•	ALL COMPONI CODE CONST		PROVED FOR USE IN	N POTABLE SYSTEMS.					

MADV DESCRIPTION		FLOW DANCE (CDM)		ELECTRIC	CAL DATA	DACIC OF DECICAL	ACCECCODIEC
MARK	DESCRIPTION	FLOW RANGE (GPM)	DROP (PSI)	VOLTAGE	DLTAGE PHASE BASIS OF DESIGN	BASIS OF DESIGN	ACCESSORIES
TMV-1	ELECTRONIC MIXING VALVE	0.25-100	5 @ 50 GPM	120	1	LEONARD NV-150-LF	1



MISSISSIPPI DEPARTMENT OF TRANSPORTATION DISTRICT 3 MATERIALS LAB HVAC AND LIGHTING REPLACEMENT

PLUMBING SCHEDULES

Project Number: BWO-3074-82(004)

COUNTY: YAZOO

발 FILENAME: BWO-3074-82(004)-P-601.dgn CHECKED DRL DATE: 10/16/17 DESIGN TEAM <u>CDFL</u>

SHEET NUMBER

WORKING NUMBER

P-601

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1-82(004)
BWO-3074-82
PM
0
12:00

		710
		17.0

G	ENERAL NOTES - DEMOLITION:
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- BIDDING THE PROJECT BY PROVIDING INFORMATION ABOUT HVAC EQUIPMENT. PIPING, AND ASSOCIATED MATERIALS AND THEIR REMOVAL. AIR DISTRIBUTION AND PIPING SYSTEMS, INCLUDING SIZES AND ROUTING, SHOWN DRAWINGS WERE TAKEN FROM EXISTING RECORD DRAWINGS AND UPDATED BY ONSITE INVESTIGATION. HOWEVER, CONTRACTOR SHALL VISIT SITE AND OBSERVE ALL EXISTING CONDITIONS RELATED TO THE WORK AND MAKE NECESSARY ADJUSTMENTS, TO FACILITATE DEMOLITION OF EXISTING AND INSTALLATION OF NEW SYSTEMS.
- B. MECHANICAL CONSTRUCTION SHALL INCLUDE ALL WORK REQUIRED FOR THE REMOVAL OF EXISTING MECHANICAL EQUIPMENT, PIPING, DUCTWORK, ETC. WHERE INDICATED OR REQUIRED TO FACILITATE NEW CONSTRUCTION. THE CONTRACTOR SHALL REMOVE FROM THE SITE ANY DUCTWORK, EQUIPMENT, VALVES, PIPING, MOTORS, CONTROLS, ETC. NOT RE-USED.
- C. WHERE NEW PIPING AND DUCT SYSTEMS ARE SHOWN TO REPLACE EXISTING SYSTEMS, THE EXISTING COMPONENTS SHALL BE REMOVED TO PERMIT THE INSTALLATION OF THE NEW SYSTEMS. NEW SYSTEMS SHALL BE COMPLETE IN ALL RESPECTS BETWEEN THE CONNECTION TO EXISTING AND NEW EQUIPMENT. OWNER SHALL HAVE FIRST RIGHTS OF REFUSAL TO ALL EXISTING DUCT, PIPING, VALVES, HANGERS, SUPPORTS, ETC THAT ARE TO BE DEMOLISHED. IF OWNER REFUSES DEMOLISHED MATERIALS, THEY SHALL BECOME THE PROPERTY OF THE CONTRACTOR AND SHALL BE REMOVED FROM THE PREMISES.
- D. IT IS MECHANICAL CONTRACTORS RESPONSIBILITY TO COORDINATE CONSTRUCTION WORK WITH GENERAL CONTRACTOR AND OTHER TRADES ON SITE. WORK PERFORMED UNDER THIS PROJECT SHALL NOT DISRUPT OR INTERFERE WITH OPERATION OF REST OF BUILDING. ANY TEMPORARY UTILITY, DUCT, ETC. CONNECTIONS NECESSARY TO MAINTAIN SERVICES ARE THE MECHANICAL CONTRACTOR'S RESPONSIBILITY.
- E. SEE ELECTRICAL DRAWINGS FOR ELECTRICAL DEMOLITION INFORMATION.
- F. NO EXISTING STRUCTURAL MEMBERS ARE TO BE CUT OR PENETRATED WITHOUT SPECIFIC AUTHORIZATION BY ARCHITECT. SEE ARCHITECTURAL AND STRUCTURAL DRAWINGS FOR ADDITIONAL INFORMATION. ALL REMAINING OPENINGS AND HOLES IN WALLS, CEILING, AND FLOORS SHALL BE PATCHED AND FINISHED UNDER DIRECTION OF PROJECT ARCHITECT/ENGINEER.
- G. MAINTAIN THE EXISTING WALL CONSTRUCTION INCLUDING FIRE RATINGS WHERE WORK IS PERFORMED.

GENERAL NOTES - NEW CONSTRUCTION:

PERCENTAGE

OF DUCT

TESTED (%)

100

10 ¹

DUCT SEALING & TESTING TABLE

POSITIVE (P) OR | MIN. PRESS.

PROJECT ENGINEER TO SELECT SECTIONS OF DUCTWORK APPROXIMATELY 1 WEEK PRIOR TO TESTING.

TAPE SHALL NOT BE USED AS THE PRIMARY SEALANT.

AS THE PRIMARY SEALANT.

FIRE DAMPERS, SMOKE DAMPERS, ETC.

TRAVERSE JOINTS ONLY.

PRESSURE | PRESS (IN WG) | LEVEL

ALL TRAVERSE JOINTS, LONGITUDINAL SEAMS, AND DUCT WALL PENETRATIONS. PRESSURE-SENSITIVE

ALL TRAVERSE JOINTS AND LONGITUDINAL SEAMS. PRESSURE-SENSITIVE TAPE SHALL NOT BE USED

LONGITUDINAL SEAMS ARE JOINTS ORIENTED IN THE DIRECTION OF AIRFLOW. TRAVERSE JOINTS ARE

PENETRATIONS ARE OPENINGS MADE BY ANY SCREW FASTENER, PIPE, ROD, OR WIRE. SPIRAL LOCK SEAMS IN A ROUND AND FLAT OVAL DUCT NEED NOT BE SEALED. ALL OTHER CONNECTIONS ARE

CONSIDERED TRAVERSE JOINTS, INCLUDING BUT NOT LIMITED TO SPIN-INS, CONICAL TAPS, OTHER

BRANCH CONNECTIONS, ACCESS DOOR FRAMES AND JAMBS, DUCT CONNECTIONS TO EQUIPMENT,

CONNECTIONS OF TWO DUCT SECTIONS ORIENTED PERPENDICULAR TO AIRFLOW. DUCT WALL

DUCT LOCATION

VRF SUPPLY DUCTS

ALL RETURN AND EXHAUST DUCTS

TO AIR TERMINAL CONNECTIONS

DUCT SEALING DEFINITIONS

LEVEL C:

GENERAL:

FROM PACKAGED UNIT SUPPLY DISCHARGE

DUCT

NEGATIVE (N) | CLASS/TEST | SEALING | LEAKAGE AT DESIGN

ALLOWABLE

AIRFLOW (%)

- A. ALL DUCTWORK AND PIPING ASSOCIATED WITH MECHANICAL (HVAC) SYSTEMS SHALL BE INSTALLED AND SECURED PER APPLICABLE BUILDING CODES ABOVE CEILINGS OR IN FURRED CHASES. PROVIDE ACCESS PANELS FOR ALL MECHANICAL EQUIPMENT INSTALLED ABOVE HARD CEILINGS OR IN FURRED CHASES REQUIRING ACCESS, SUCH AS FIRE DAMPERS, VOLUME DAMPERS, PIPING, VALVES, ETC.
- B. MECHANICAL CONTRACTOR SHALL COORDINATE AIR DISTRIBUTION DEVICE LAYOUT WITH ARCHITECTURAL REFLECTED CEILING PLANS. LIGHT FIXTURE LOCATIONS SHOWN ON ELECTRICAL DRAWINGS TAKE PRIORITY OVER AIR DISTRIBUTION DEVICE LOCATIONS.
- C. MECHANICAL CONTRACTOR SHALL INSTALL VOLUME DAMPERS IN ALL BRANCH DUCTS TO SUPPLY, RETURN, OR EXHAUST GRILLES EXCEPT IN LOCATIONS WHERE THE DRAWINGS/SCHEDULES CALL FOR VOLUME DAMPERS INTEGRAL TO DIFFUSERS. VOLUME DAMPERS SHALL BE LOCATED FOR ACCESS FROM LAT CEILING OR ACCESS PANELS. CONTRACTOR TO INSTALL FLAGGING TAPE AT EACH VOLUME DAMPER LOCATION.
- D. FLEXIBLE DUCT RUNOUTS TO SUPPLY DIFFUSERS SHALL NOT EXCEED 5'-0" IN LENGTH, AND SHALL BE INSTALLED ONLY ON SUPPLY AIR. NO FLEX WILL BE ALLOWED ON RETURN OR EXHAUST SYSTEMS. FOR ALL DUCT SYSTEMS, TAPS OFF MAIN TRUNK DUCTS SHALL BE CUT INTO THE SIDES OR BOTTOM OF DUCT ONLY.
- E. SEE SPECIFICATION FOR DUCT LEAK TESTING REQUIREMENTS. FOR ALL DUCT SYSTEMS THAT REQUIRE TESTING, ALL COMPONENTS IN THE MAIN DUCT (FITTINGS, FIRE DAMPERS, SMOKE DAMPERS, BRANCH TAPS, ETC.) MUST BE INSTALLED PRIOR TO TESTING. THE CONTRACTOR MUST GIVE ADEQUATE ADVANCE NOTICE OF THE TESTING TO THE PROJECT ENGINEER.
- F. PROVIDE AND INSTALL FIRE DAMPERS IN ALL DUCTWORK THAT PENETRATE FIRE RATED WALLS OR FLOORS. REFER TO ALL APPLICABLE BUILDING CODES AND SPECIFICATIONS PERTAINING TO THIS PROJECT.
- G. FIRE STOP ALL PIPES AND DUCTS THAT PENETRATE RATED WALLS, FLOORS, AND CEILINGS. REFER TO BUILDING CODES AND SPECIFICATIONS FOR APPROVED FIRE PROOFING MATERIALS AND METHODS.
- H. SEE LIFE SAFETY PLANS FOR REQUIRED RATING OF FIRE DAMPERS.
- I. PROVIDE ACCESS PANELS FOR ALL FIRE AND SMOKE DAMPERS.
- J. REFER TO MECHANICAL DETAILS FOR TYPICAL INSTALLATION OF HVAC EQUIPMENT.
- K. MECHANICAL CONTRACTOR TO COORDINATE ALL ROOF, WALL, AND FLOOR PENETRATIONS WITH GENERAL WORKS CONTRACTOR.
- L. REMOVAL OF CROSS BRACING TO FACILITATE DUCT ROUTING, MUST BE APPROVED BY THE STRUCTURAL ENGINEER.
- M. PROVIDE AND INSTALL AUTOMATIC HIGH CAPACITY AIR VENTS AT HIGH POINTS FOR ALL HYDRONIC PIPING SYSTEMS. PROVIDE AND INSTALL MANUAL DRAINS AT LOW POINTS FOR ALL HYDRONIC PIPING SYSTEMS.
- N. ALL REFRIGERANT PIPING TO BE SIZED AND INSTALLED PER MANUFACTURER'S GUIDELINES. CONTRACTOR TO PROVIDE LAYOUT WITH SUBMITTAL INDICATING PIPING SIZES, SPECIAL FITTINGS, ETC. WITH CONSIDERATION GIVEN TO PIPING LENGTH, EQUIPMENT CAPACITY AND OPERATING CONDITIONS.
- O. CONTRACTOR TO PROVIDE ENGINEERED SHOP DRAWING FOR LOCATION OF ANCHORS, GUIDES, AND EXPANSION COMPENSATORS IN CHILLED AND HEATING WATER PIPING SYSTEMS. ALL COMPONENTS SHALL BE INSTALLED PER MANUFACTURER'S GUIDELINES IN REGARD TO WELDING AND FASTENING OF DEVICES AND REQUIRED SPACING FOR ANCHORS AND GUIDES. SEE SPECIFICATION FOR ADDITIONAL INFORMATION.
- P. CONTRACTOR SHALL REFER TO ARCHITECTURAL PLANS FOR PHASING OF WORK.

	HVAC	<u>LEGEND</u>	
CONDENSATE PIPING	CD	NEW EQUIPMENT	
DRAIN PIPING	D	BALL VALVE	—— -
STORM DRAIN	SD	GATE VALVE	_₹ OR₹_
FIRE PROTECTION LINE	F	GLOBE VALVE	
CHILLED WATER SUPPLY	cws	BUTTERFLY VALVE	I
CHILLED WATER RETURN	CWR	CHECK VALVE	OR
HEATING WATER SUPPLY	HWS	BALANCING VALVE	⊕ OR ∳ _
HEATING WATER RETURN	HWR	2-WAY CONTROL VALVE	——————————————————————————————————————
TEMPERATURE SENSOR	T	3-WAY CONTROL VALVE	
HUMIDITY SENSOR	\mathbb{H}	PRESSURE REDUCING VALVE	
CO ² SAMPLE PORT	(CO2)	RELIEF VALVE	_{5 OR
BUILDING MANAGEMENT SYSTEM	BMS	GAS COCK	Φ
SPLITTER DAMPER	0)	FLOW MEASURING DEVICE	*
FLEXIBLE CONNECTION		REDUCER	
VOLUME DAMPER	₽ P	MANUAL AIR VENT	<u> </u>
MOTORIZED DAMPER	M T	GAGE COCK	_
FIRE DAMPER OR SMOKE DAMPER	FD ◆ OR SD ◆	WYE STRAINER	
BRANCH TAP FITTING		UNION	II
TURNING VANES	1000	THERMOMETER	
GRILL MARK/CFM QUANTITIY	○ ₃₀₀	THERMOMETER WELL	т
SUPPLY DUCT SECTION		GAUGE	Q
RETURN DUCT SECTION		CONNECT TO EXISTING	•
OUTSIDE VENTILATION AIR DUCT SECTION		LIMIT OF DEMOLITION	O
ROUND DUCT SIZE - INCHES	12	ELBOW TURNING DOWN	———э
RECTANGULAR DUCT SIZE - INCHES	12x12	ELBOW TURNING UP	
OVAL DUCT SIZE - INCHES	12/12	DIRECTION OF FLOW	
ELBOW UP (SUPPLY)		FUEL OIL SUPPLY	FOS
ELBOW DOWN (SUPPLY)	×	FUEL OIL RETURN	FOR
PLAN NOTE DESIGNATION	(#)		

	HVAC ABBREVIATIONS								
AD	ACCESS DOOR	ER	EXHAUST REGISTER	RA	RETURN AIR				
AFF	ABOVE FINISHED FLOOR	FC	FLEXIBLE CONNECTION	RAG	RETURN AIR GRILL				
AL	ACOUSTICAL LINING	FD	FIRE DAMPER	RAR	RETURN AIR REGISTER				
AMD	AUTOMATIC MOTORIZED DAMPER	HC	HEATING COIL	TR	TOP REGISTER				
BE	BOTTOM ELEVATION	HPS	HIGH PRESSURE STEAM	VAV	VARIABLE AIR VOLUME				
BR	BOTTOM REGISTER	LPS	LOW PRESSURE STEAM	VD	VOLUME DAMPER				
CD	CEILING DIFFUSER	MPS	MEDIUM PRESSURE STEAM	WMS	WIRE MESH SCREEN				
CR	CEILING REGISTER	NTS	NOT TO SCALE						
ပ္	CENTERLINE	OA	OUTSIDE AIR						



MISSISSIPPI DEPARTMENT OF TRANSPORTATION DISTRICT 3 MATERIALS LAB HVAC AND LIGHTING REPLACEMENT

HVAC GENERAL NOTES & LEGEND

Project Number: BWO-3074-82(004)

DESIGN TEAM CDFL

COUNTY: YAZOO FILENAME: BWO-3074-82(004)-M-001.dgn

M-001 SHEET NUMBER CHECKED DRL DATE: 10/16/17

881881

WORKING NUMBER

PROJECT NO.

BWO-3074-82(004)

STATE

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