STATE OF MISSISSIPPI

MISSISSIPPI DEPARTMENT OF TRANSPORTATION


PLANS OF PROPOSED

PHILADELPHIA PROJECT OFFICE HVAC AND LIGHTING RENOVATION

STATE PROJECT NO. BWO-5174-50(002)

NESHOBA COUNTY

CONSTRUCTION FMS NOS. 503123 /301000

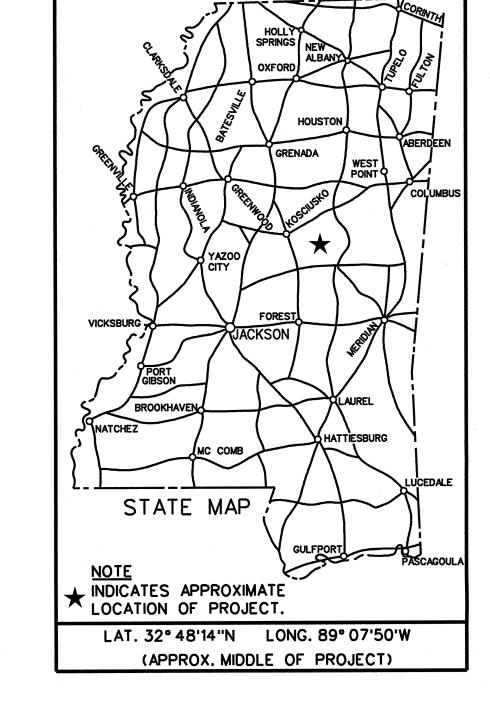

STATE | PROJECT NO.


BW0-5174-50(002


PROJECT SITE


1115 Highway 15 Bypass, Philadelphia, MS 39350






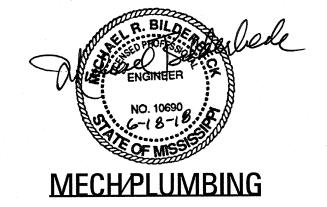

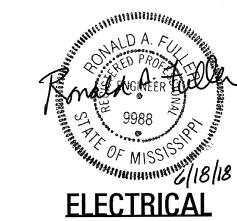

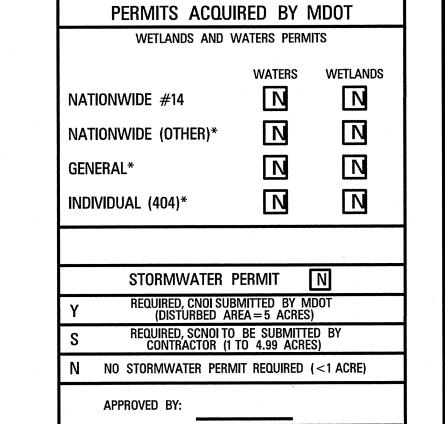


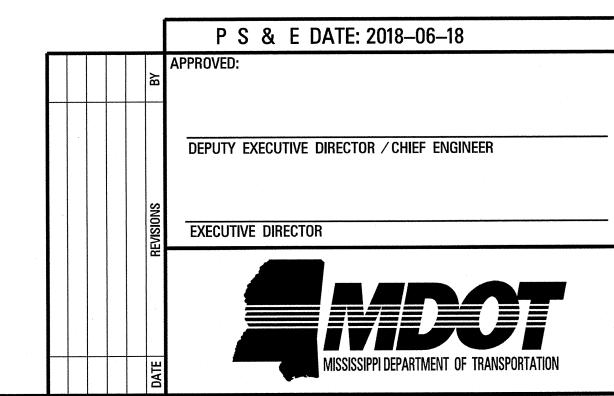

(1)		INDEX OF DRAWINGS
Working No.	Sheet No.	Sheet Name
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A101	3	DEMOLITION PLAN
A201	4	FINSH FLOOR PLAN
P130	5	PLUMBING FLOOR PLAN
M0.1	6	HVAC SCHEDULES, GENERAL NOTES AND LEGEND
M120	7	HVAC DEMOLITION FLOOR PLAN
M130	8	HVAC RENOVATION FLOOR PLAN
E001	9	ELECTRICAL LEGEND, ABBREVIATIONS, AND GENERAL NOTES
E101	10	LIGHTING DEMOLITION PLAN - ADMINISTRATION BUILDING
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E202	13	POWER PLAN - ADMINISTRATION BUILDING
E501	14	ELECTRICAL DETAILS


NOTE: TEXT & DIMS

SCALE: 1/4" =1'-0"

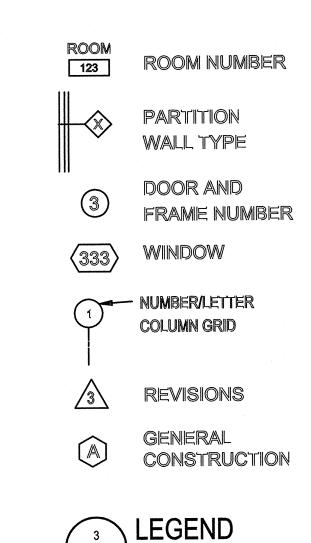




ARCHITECTURAL

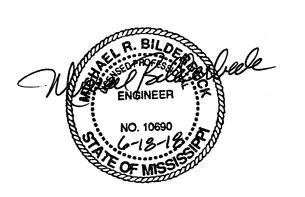

MECH/PLUMBING



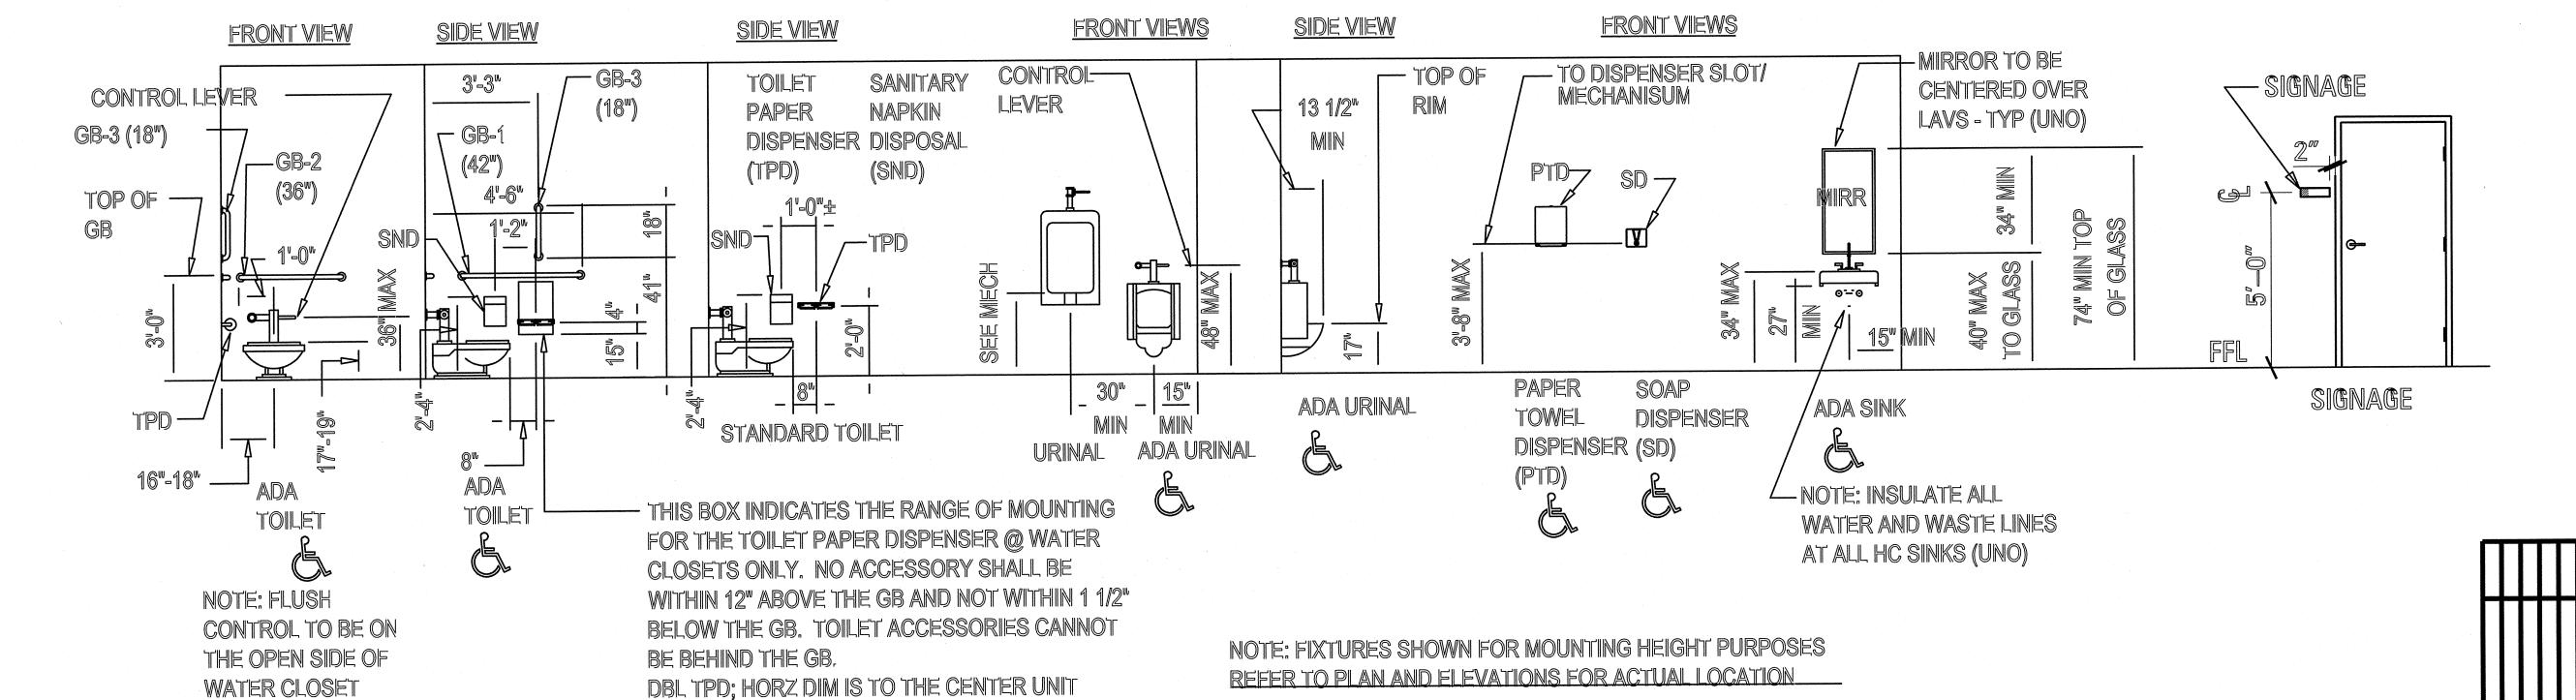

	PS & E PLANS-DATE2018-06-18											
	FMS CON. • 503123/301000											
	REVISIONS											
	DATE	SHEET NO.	BY									
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Project Number: BW0-5174-50(002)

WORKING NUMBER
T101
SHEET NUMBER
2



DEMOLITION NOTES:

(DEMOLITION PLAN AND NOTES ARE FOR GENERAL REFERENCE AND DIRECTION. IT IS ADVISED THAT CONTRACTOR VISIT SITE BEFORE BID TO BEST PRICE DEMOLITION COSTS.)

- 1. REMOVE TOILET PARTITIONS AND DOORS
- 2. REMOVE URINALS AND RELATED EXPOSED PLUMBING
- 3. REMOVE TOILETS AND RELATED EXPOSED PLUMBING
- 4. REMOVE LAVATORIES AND RELATED EXPOSED PLUMBING
- 5. REMOVE TOILET ACCESSORIES
- 6. REMOVE CERAMIC TILE FLOOR & WALLS (TOILETS, RECEPT.)
- 7. REMOVE ACOUSTICAL CEILING AND GRID
- 8. REMOVE AND STORE DRINKING FOUNTAIN. REINSTALL AFTER PAINTING IS COMPLETE.
- 9. REMOVE EXISTING BULLETIN BOARD CABINET RM127
- 10. REMOVE EXISTING REFRID., RANGE, MICROWAVE AND DELIVER TO OWNER.
- 11. REMOVE EXISTING WINDOW BLINDS
- 12. REMOVE WALLPAPER RM103, RM100, RM102
- 13. REMOVE RUBBER BASE
- 14. REMOVE EXISTING CARPET
- 15. REMOVE EXISTING OUTLET COVERS AND DEVICES SUCH AS THERMOSTATS, FIRE ALARM, ETC., BEFORE PAINTING. REINSTALL AFTER PAINTING IS COMPLETE.
- 16. REMOVE SIGNAGE, STORE, AND REINSTALL AFTER PAINTING IS COMPLÉTE.
- 18. REMOVE EXISTING CORNER GUARDS
- 19. REMOVE SINKS AND RELATED EXPOSED PLUMBING IN ROOMS 125 AND 127
- 20. REMOVE COUNTERTOPS FROM ALL EXISTING MILLWORK AND BASE CABINETS.



MISSISSIPPI DEPARTMENT OF TRANSPORTATION PHILADELPHIA PROJECT OFFICE HAVO **& LIGHTING RENOVATION**

DEMOLITION PLAN

Project Number: . BWO-5174-50(002)


COUNTY: NESHOBA

FILENAME: DemoPlan

SHEET NUMBER

A101

CHECKED ASU DATE: 2018-06-18 DESIGN TEAM____ASU

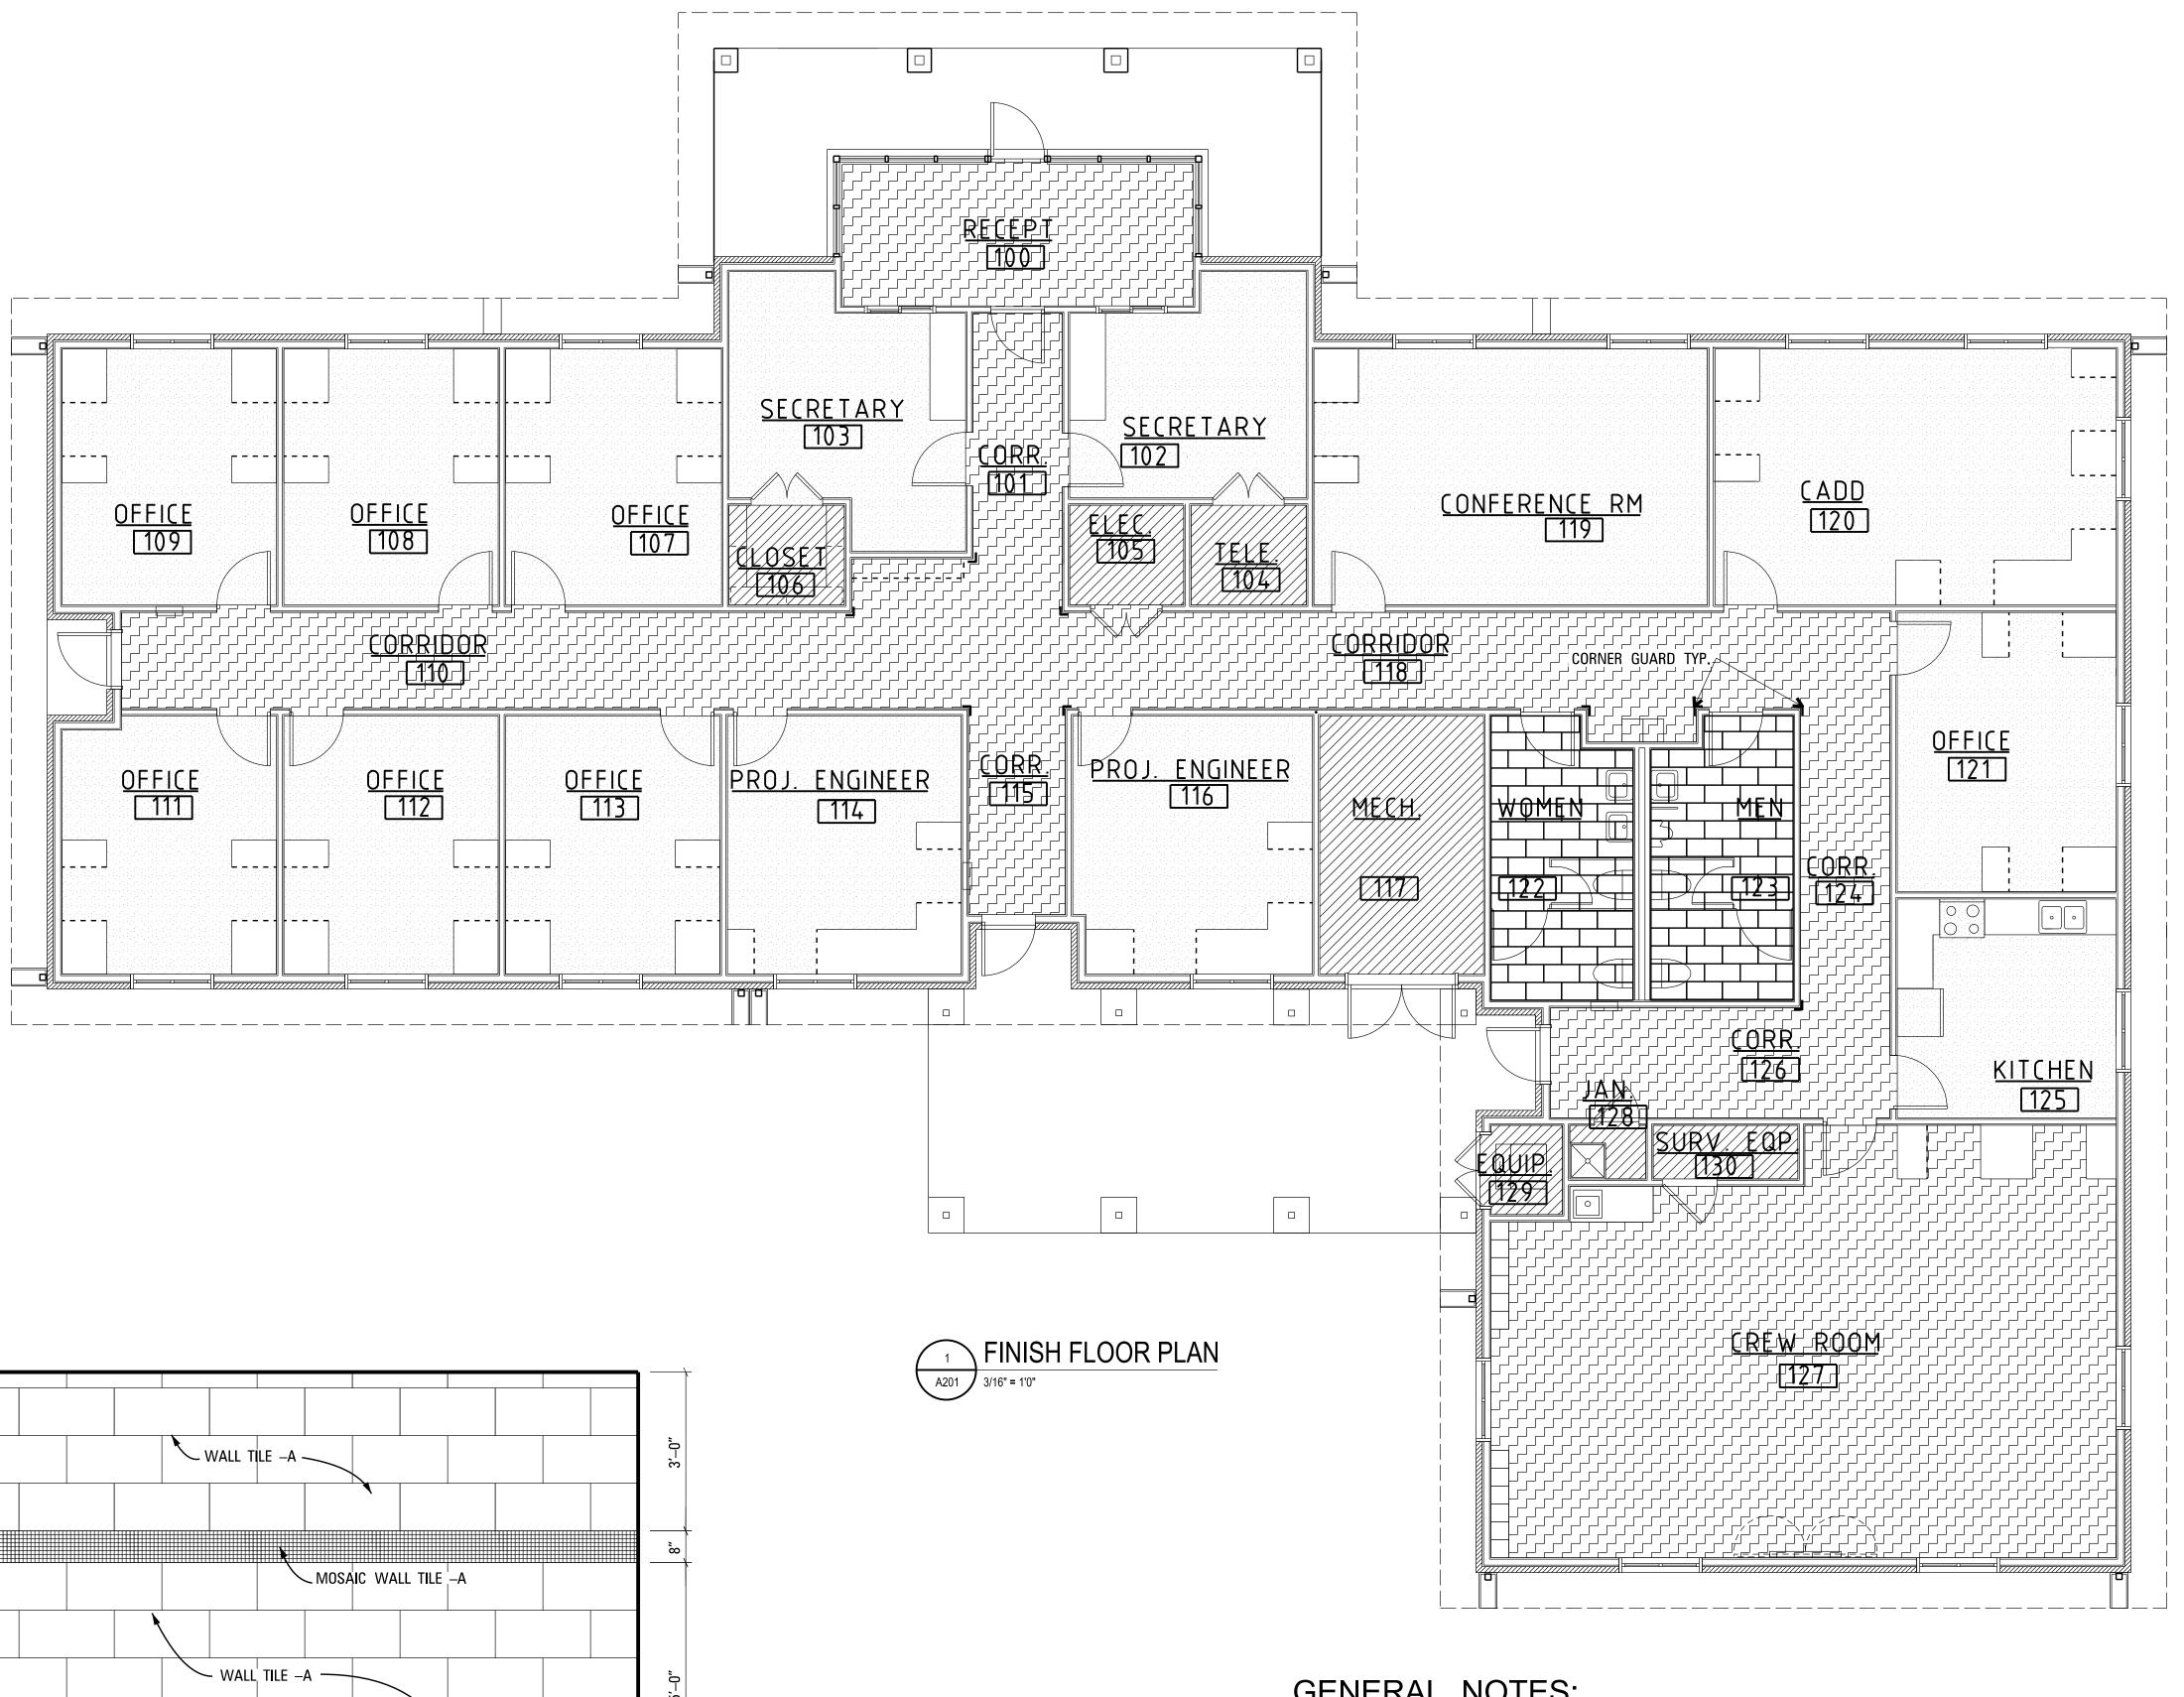


RESTROOM WALL TILE

A201 / 1/2" = 1'0"

FINISH NOTES:

(FINISH PLAN AND NOTE ARE FOR GENERAL REFERENCE AND DIRECTION. IT IS ADVISED THAT CONTRACTOR VISIT SITE BEFORE BID TO BEST PRICE FINISH COSTS.)

- 1. PREP AND PAINT ALL EXPOSED SURFACES
- 2. PREP VCT TO RECEIVE NEW TEXTILE COMPOSITE FLOORING.
- 3. INSTALL NEW CEMENT BOARD AT WALLS TO RECIEVE CERAMIC TILES. (TOILET ROOMS)
- 4. INSTALL CERAMIC WALL AND FLOOR TILES IN TOILET ROOMS.
- 5. INSTALL NEW FORMICA CLAD COUNTERTOPS WITH T-MOLD EDGE.
- 6. INSTALL NEW TOILET PARTITIONS AND ACCESORIES AFTER NEW TOILET FIXTURES HAVE BEEN INSTALLED.
- 7. PAINT FORMICA WINDOW SILLS AT RECEPTION 100 AND SECRETARY OFFICES 102 AND 103
- 8. INSTALL NEW FLOORING AS SHOWN ON PLAN.
- 9. INSTALL NEW ACOUSTICAL PANEL CEILING SYSTEM. COORDINATE WITH ELECTRICAL AND MECHAINICAL.
- 10. INSTALL NEW CORNER GUARDS.
- 11. INSTALL NEW KITCHEN APPLIANCES (REFRIG., RANGE, AND MICROWAVE)
- 12. INSTALL NEW WINDOW BLINDS
- 13. INSTALL NEW SINKS, SAME SIZE AS EXISTING, AT ROOMS 125 AND 127. REFER TO PLUMBING FOR MORE INFORMAION.
- 15. INSTALL NEW RUBBER BASE IN ALL SPACES.

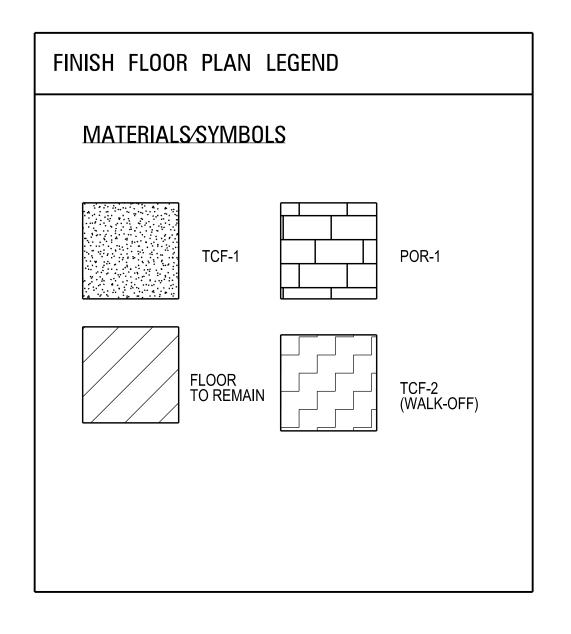

GENERAL NOTES:

- 1. VERIFY EXACT FINISHES WITH PROJECT ENGINEER BEFORE INSTALLATION AND OR APPLICATION.
- 2. REFER TO SPECIFICATIONS FOR MORE DETAIL INFORMATION ON FINISH MATERIALS TO BE PROVIDE IN CONTRACT.



MISSISSIPPI DEPARTMENT OF TRANSPORTATION HII PHILADELPHIA PROJECT OFFICE HAVO & LIGHTING RENOVATION

FINISH FLOOR PLAN

Project Number: . BWO-5174-50(002)


COUNTY: NESHOBA

FILENAME: FlrFinishPlan

SHEET NUMBER

A201

CHECKED ASU DATE: 2018-06-18 DESIGN TEAM_ ASU

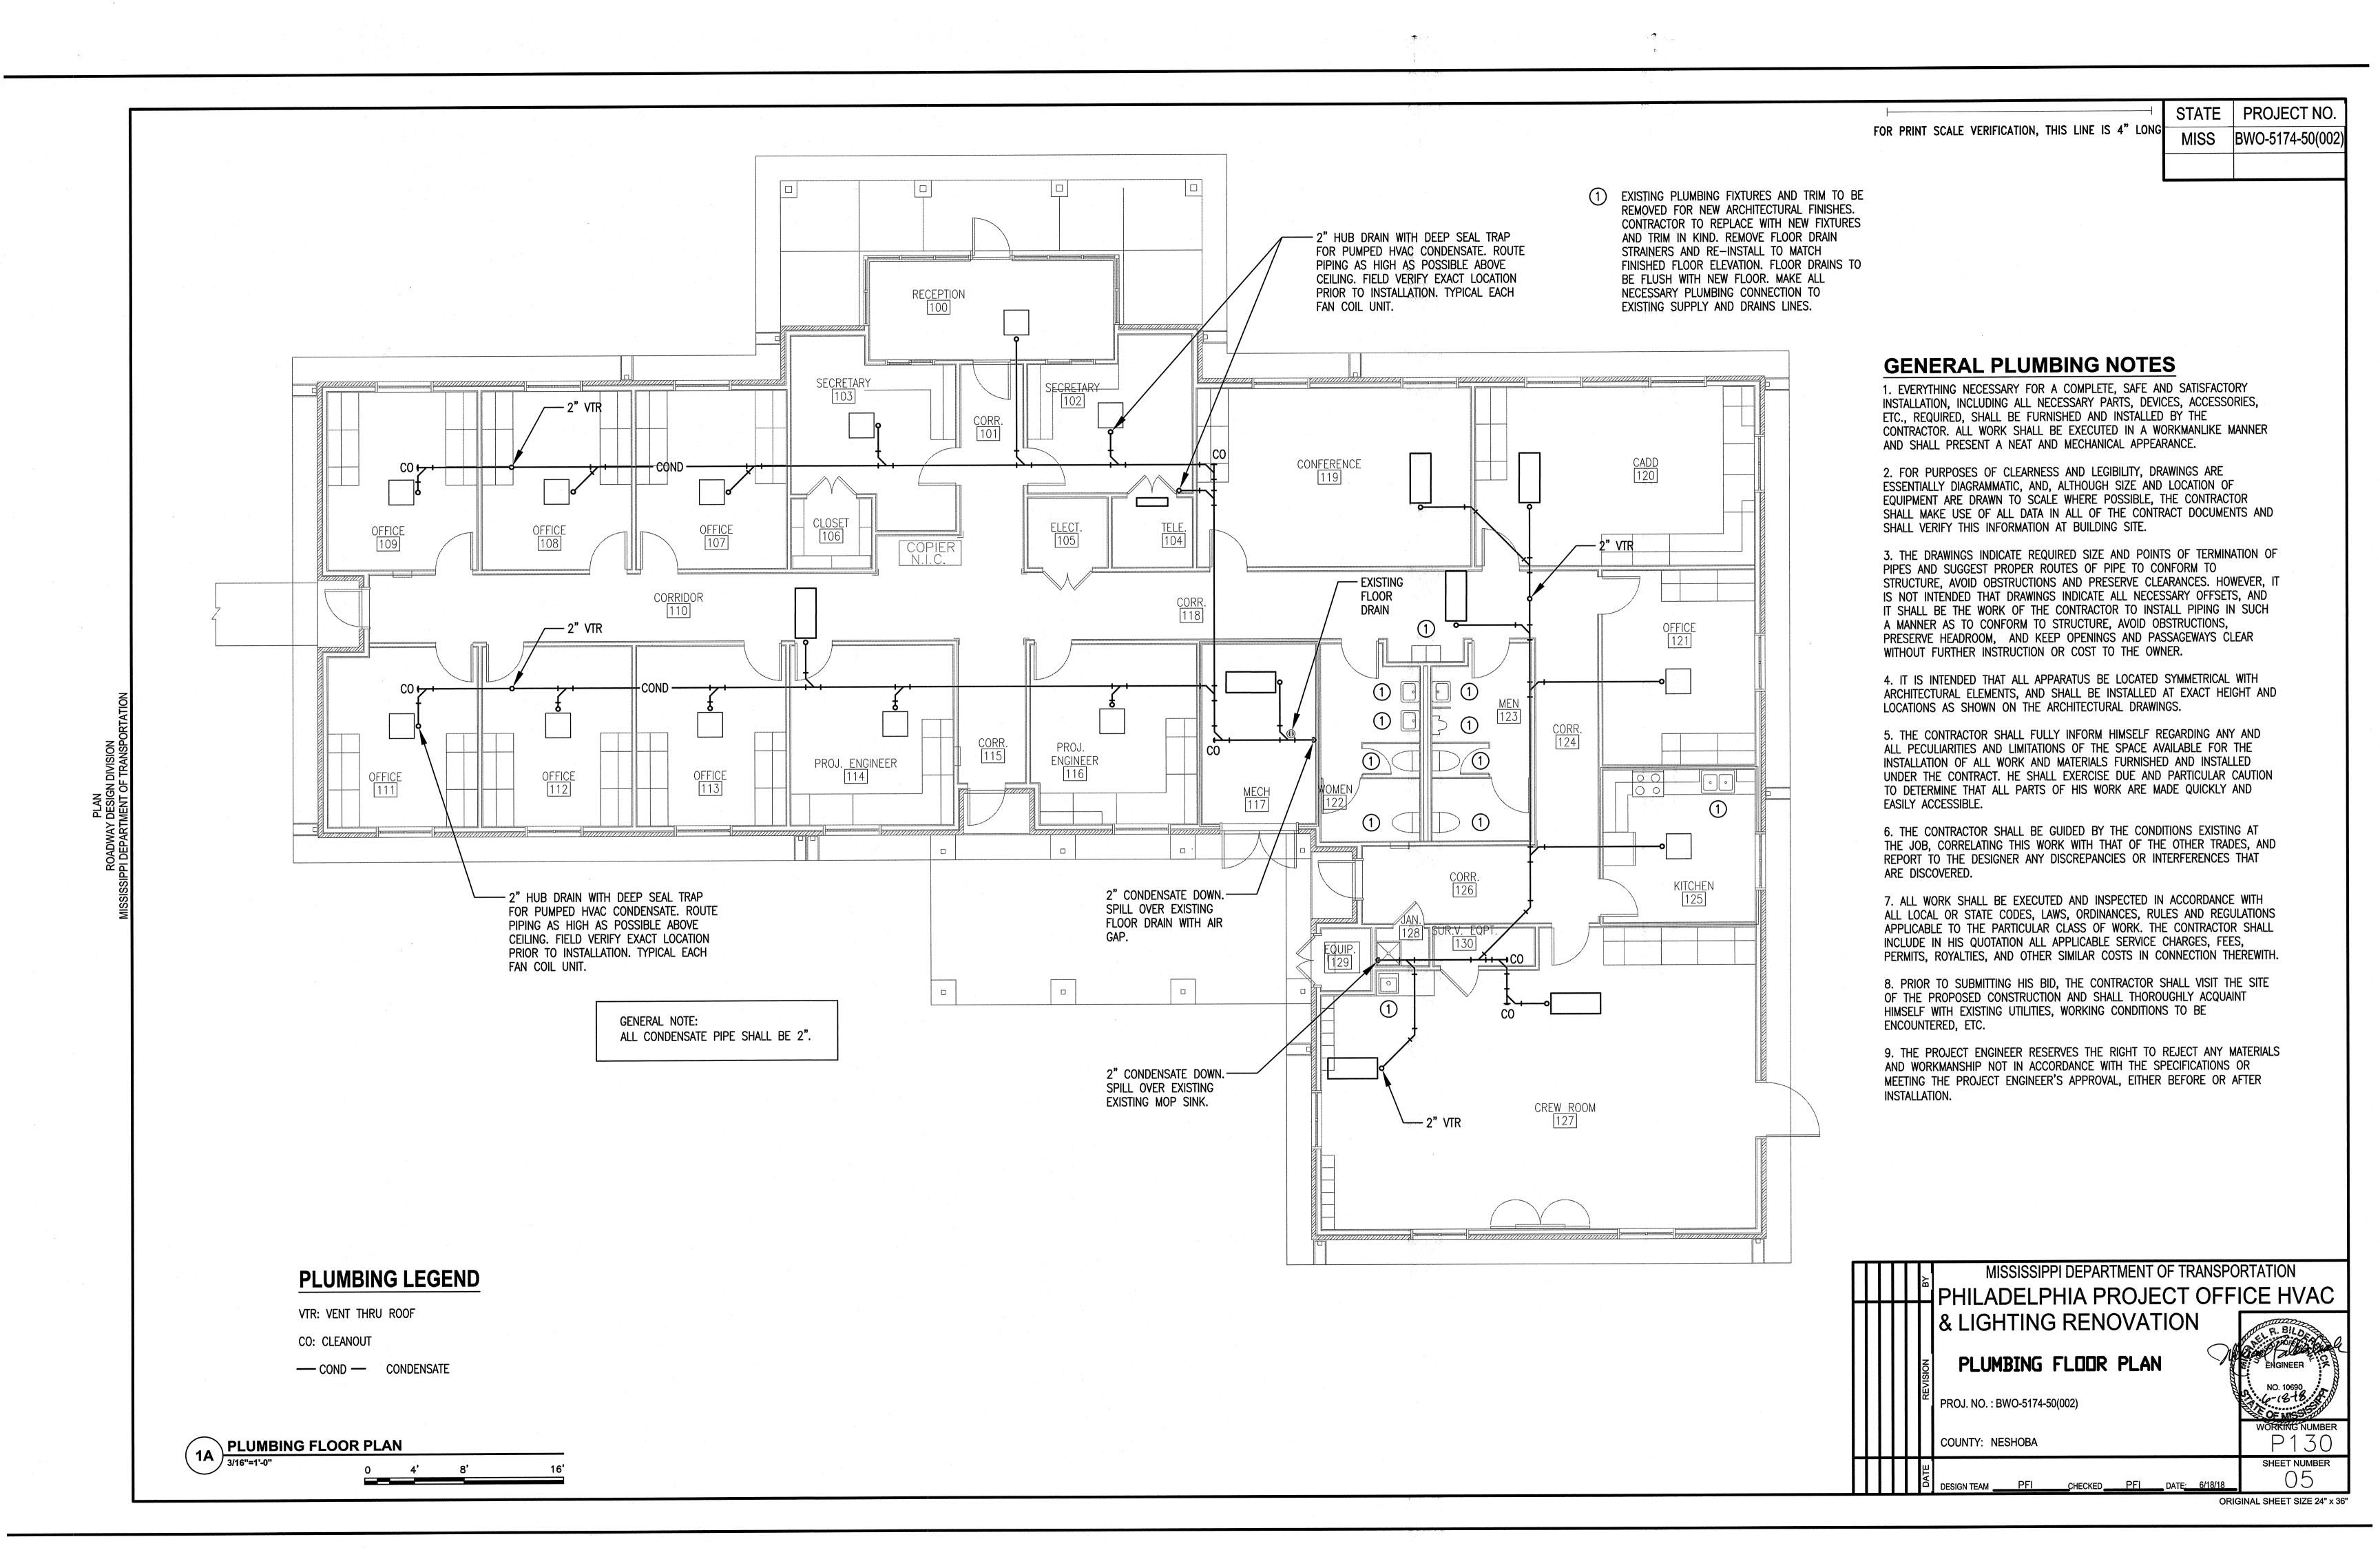


FAN COIL AND CONDENSING UNIT SCHEDULE																	
						\$1 1	INDOOR	UNIT						OUT	DOOR UNIT		
CFM		MIN	EXT	СО	OLING		HEA	ATING	BASIS OF	LOCATION	MADK	COOLING CAP.	EL	ECTRICA	L DATA	BASIS OF	NOTES
MARK	(HIGH)	O/A	S.P.	TOTAL	E./	\.T.	CAP	E.A.T.	DESIGN	LOCATION	MARK	95°F AMB.	MCA	МОСР	VOLTAGE	DESIGN	HOIL
				(MBH)	D.B.	W.B.	(MBH)	D.B.				(MBH)	WICA	WIGGI	VOLIAGE		
FCU-1	300	-0-	0.10"	9	80	67	· -	-	DAIKIN FTK09	—— ; ·	CU-2	9	7	15	208V/1φ	DAIKIN RK09	1, 2

- 1. PROVIDE WITH LOCKING MOUNT KIT, CONDENSATE PUMP, LOW AMBIENT CONTROLLER, WINTER START KIT, WIND BAFFLE, CRANKCASE HEATER, START ASSIST, AND LIQUID LINE SOLENOID.
- 2. PROVIDE REFRIGERANT PIPING SIZED PER MANUFACTURER'S RECOMMENDATIONS
- 3. PROVIDE EQUIVALENT UNIT BY LG OR MITSUBISHI

HEAT PUMP CONDENSING UNIT SCHEDULE (VRF)											
MARK	COOLING TONS	EL	ECTRICAL	. DATA	SERVISE	BASIS OF DESIGN					
MAKK	CAP 95 AMB.	MCA	MOCP	VOLTAGE	0202						
CU-1	28	2 0 61.9	2 @ 70	208/3	OFFICE	DAIKIN REYQ336					

- 1. PROVIDE EQUIVALENT BY LG OR MITSUBISHI
- 2. REF. LINES SIZED BY MFG.
- 3. PROVIDE LOW AMBIENT COOLING
- 4. PROVIDE HAIL GUARDS

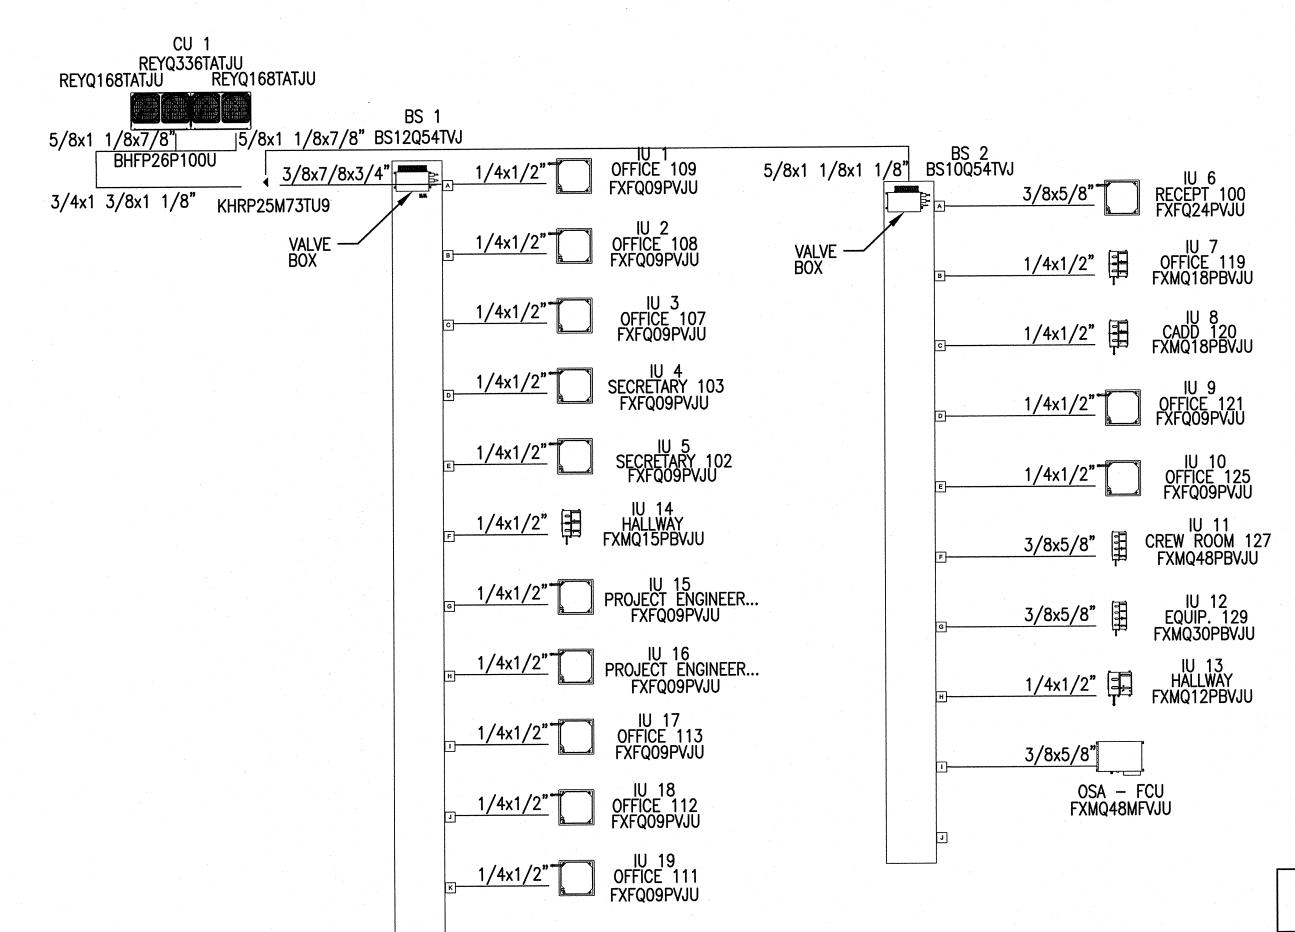

FOR PRINT SCALE VERIFICATION, THIS LINE IS 4" LONG

STATE | PROJECT NO. MISS | BWO-5174-50(002)

AIR DISTRIBUTION SCHEDULE

-	MARK	AIR I	FLOW	NECK	DANIEL CIZE	CED/MOE	FRAME	DEMARKS	
		MIN.	MAX.	DIA.	PANEL SIZE	SERVICE	TYPE	REMARKS	
	A	0	100	6	12x12	SUPPLY	LAY-IN	SQUARE LOUVER-FACE DIFFUSER WITH ROUND NECK	
	B	SEE DWGS.	SEE DWGS.	SEE DWGS.	12x12	EXHAUST	SURFACE	ALUMINUM BAR-TYPE WITH 3/4" SPACED BLADES	
	©	SEE DWGS.	SEE DWGS.	SEE DWGS.	24x24	RETURN/ EXHAUST	LAY-IN	ALUMINUM BAR-TYPE WITH 3/4" SPACED BLADES	
	(D)	110	150	8	24x24	SUPPLY	LAY-IN	SQUARE LOUVER—FACE DIFFUSER WITH ROUND NECK	
	E	375	560	12	24x24	SUPPLY	LAY-IN	SQUARE LOUVER—FACE DIFFUSER WITH ROUND NECK	
	Ð	635	635	14	24x24	SUPPLY	LAY-IN	SQUARE LOUVER—FACE DIFFUSER WITH ROUND NECK	
	©			SEE DWGS.	SEE DWGS.	SUPPLY	SURFACE	ALUMINUM BAR-TYPE SUPPLY EQUAL TO TITUS 300FS	
	\oplus		<u> </u>	SEE DWGS.	SEE DWGS.	RETURN	SURFACE	ALUMINUM BAR-TYPE WITH 3/4" SPACED BLADES	

PROVIDE 6" HIGH SQUARE / ROUND TRANSITION ON B & C PROVIDE UNITS BY KRUGER, T & B, OR TITUS

		FA	N COI	L UNI	T SCI	HEDUL	.E (V	(RF)	
MADIZ	CEM	C00	LING	HEA	HEATING		FLA	AREA SERVED	
MARK	CFM	SEN. MBH	EAT DB/WB	MBH	EAT	VOLTAGE	165	ANEA SERVED	
IU-1	460	7.1	75/64	11.5	65	230/1	.3	OFFICE 109	
IU-2	460	7.1	75/64	11.5	65	230/1	.3	OFFICE 108	
IU-3	460	7.1	75/64	11.5	65	230/1	.3	OFFICE 107	
IU-4	460	7.1	75/64	11.5	65	230/1	.3	SECRETARY 103	
IU-5	460	7.1	75/64	11.5	65	230/1	.3	SECRETARY 102	
IU-6	780	15.6	75/64	29.5	65	230/1	.5	RECEPT 100	
IU-7	635	12.4	75/64	21.9	65	230/1	1.6	OFFICE 119	
IU-8	635	12.4	75/64	21.9	65	230/1	1.6	CADD 120	
IU-9	460	7.1	75/64	11.5	65	230/1	.3	OFFICE 121	
IU-10	460	7.1	75/64	11.5	65	230/1	.3	OFFICE 125	
IU-11	1,377	29.1	75/64	59.0	65	230/1	3.4	CREW RM. 127	
IU-12	1,094	19.1	75/64	37.1	65	230/1	2.8	EQUIP. 129	
IU-13	450	7.8	75/64	14.9	65	230/1	1.4	HALLWAY	
IU-14	560	10.0	75/64	18.0	65	230/1	1.5	HALLWAY	
IU-15	460	7.1	75/64	11.5	65	230/1	.3	PROJ. ENG. 116	
IU-16	460	7.1	75/64	11.5	65	230/1	.3	PROJ. ENG. 114	
IU-17	460	7.1	75/64	11.5	65	230/1	.3	OFFICE 113	
IU-18	460	7.1	75/64	11.5	65	230/1	.3	OFFICE 112	
IU-19	460	7.1	75/64	11.5	65	230/1	.3	OFFICE 111	
IU-FCU	636		80.1/68.5	30.0	53.5	230/1	1.9	BUILDING OSA	

PROVIDE EQUIVALENT UNIT BY LG OR MITSUBISHI

- 1. BUILT-IN CONDENSATE PUMP FOR ALL INDOOR UNITS.
- 2. RETURN AIR FILTER RACK WITH 1" FILTERS FOR DUCTED UNITS.
- 3. PROVIDE ISOLATION BALL VALVES ON BOTH SIDES OF BS BOX AND ALL SPARE PORTS.
- 4. 10-YEAR COMPLETE PARTS WARRENTY ON COMPRESSOR AND ALL UINITS.
- 5. SERVICE ACCESS FROM BELOW.
- 6. PROVIDE 7-DAY PROGRAMMABLE THERMOSTATS.

<u> </u>	EXISTING TO BE REMOVED
	WORK IN CONTRACT
	SUPPLY AIR DIFFUSER
	RETURN OR EXHAUST GRILL
	DUCT TRANSITION
	MANUAL DAMPER
	TURNING VANES
	THERMOSTAT

LEGEND

1

EXISTING TO REMAIN

SHEET METAL DUCT

ENERGY RECOVERY VENTILATOR SCHEDULE

MARK		utside Ir	SUPPLY AIR		SPACE EXHAUST AIR		EXHAUST AIR			ELECTRICAL			BASIS OF	
	CFM	DB/WB	CFM	DB/WB	CFM	DB/WB	CFM	DB/WB	ESP	VOLTS/PH/HZ	MCA	MOCP	DESIGN	
ERV-1 (SUMMER OPERATION)	610	93/79	610	80.1/68.5	510	75/63	510	90.5/76.3	.4	120/1/60	14.7	20	GREENHECK HRU-1 ECM	
ERV-1 (WINTER OPERATIONS)	610	10	610	53.5	510	70	510	18	.4				· 	

UNIT SHALL BE AHRI CERTIFIED & ETL LISTED.

MISSISSIPPI DEPARTMENT OF TRANSPORTATION PHILADELPHIA PROJECT OFFICE HVAC HVAC SCHEDULES, GENERAL NOTES AND LEGEND & LIGHTING RENOVATION

PROJ. NO. : BWO-5174-50(002)

COUNTY: NESHOBA

SHEET NUMBER 06

ORIGINAL SHEET SIZE 24" x 36"

WORKING NUMBER